



E1 EXISTING CURTAIN WALL SYSTEM  $\langle$  E2  $\rangle$  EXISTING FIRE RATED DEMISING WALL: (2HR) ── 8" CONCRETE MASONRY UNITS E3 EXISTING FIRE RATED DEMISING WALL: (2HR) 5/8" TYPE "X" GWB 3 5/8" STEEL STUDS @ 24" O.C. BATT INSULATION IN CAVITIES 1" AIR SPACE 8" CONCRETE WALL ⟨E4⟩ EXISTING EXTERIOR WALL: 2 1/2" STEEL STUDS @ 24" O.C BATT INSULATION IN CAVITIES 1" AIR SPACE 8" CONCRETE WALL RIGID INSULATION RAIN SCREEN EXTERIOR CLADDING (FLOOR/CEILING ASSEMBLY) F1 POLISHED CONC. FLOOR FINISH 2" CONCRETE TOPPING 2" REVEAL "Q" DECK F2 2" CONCRETE TOPPING 2" REVEAL "Q" DECK FURRING CHANNEL 5/8" GYPSUM WALL BOARD F3 POLISHED CONC. FLOOR FINISH 2" CONCRETE TOPPING 2" REVEAL QDECK 3 1/2" INSULATED COOLER PANEL BY MANUFACTURER **SET-OUT POINT @ SOUTH WEST** 

PARTITION SCHEDULE:

PARTITION - NON-RATED

5/8" GYPSUM WALL BOARD,

5/8" GYPSUM WALL BOARD

5/8" GYPSUM WALL BOARD

5/8" GYPSUM WALL BOARD

(NON-LOADBEARING)

3 5/8" STEEL STUDS

(NON-LOADBEARING)

1-1/2" FURRING CHANNEL EXISTING 8" CMU WALL

5/8" GYPSUM WALL BOARD

3-5/8" STEEL STUD @ 24" O.C.

EXISTING 8" CMU WALL

5/8" CEMENT BOARD

FRAME HEIGHT

P5 FURRING

3-5/8" STEEL STUD @ 16" O.C.

3-5/8" STEEL STUDS @ 24" O.C.

P2 PARTITION (FULL HEIGHT) - NON-RATED

3-5/8" STEEL STUDS @ 24" O.C.

(NON-LOADBEARING)(SEÉ STRUCTURAL)

P3 COOLER INSULATED PARTITION - NON-RATED

5/8" GYPSUM WALL BOARD - PAINTED

⟨P3a⟩ COOLER INSULATED PARTITION - NON-RATED

P4 PARTITION (42" HIGH A.F.F.) - NON-RATED

1-1/2" FURRING CHANNEL @ 16" O.C.

P6 PARTITION - NON-RATED (NON-LOADBEARING)

ACOUSTIC BATT INSULATION IN CAVITY

(ACOUSTIC SEPARATION, WET AREA ON 1 SIDE)

FRP (FIBER-REINFORCED PANEL) TO TOP OF DOOR


EXISTING WALLS (PER BASE BUILDING ARCH PARTITION SCHEDULE)

COOLER INSULATED PANELS (BY MANUFACTURER)

COOLER INSULATED PANELS BY MANUFACTURER

(NON-LOADBEARING)

(NEW WALL)

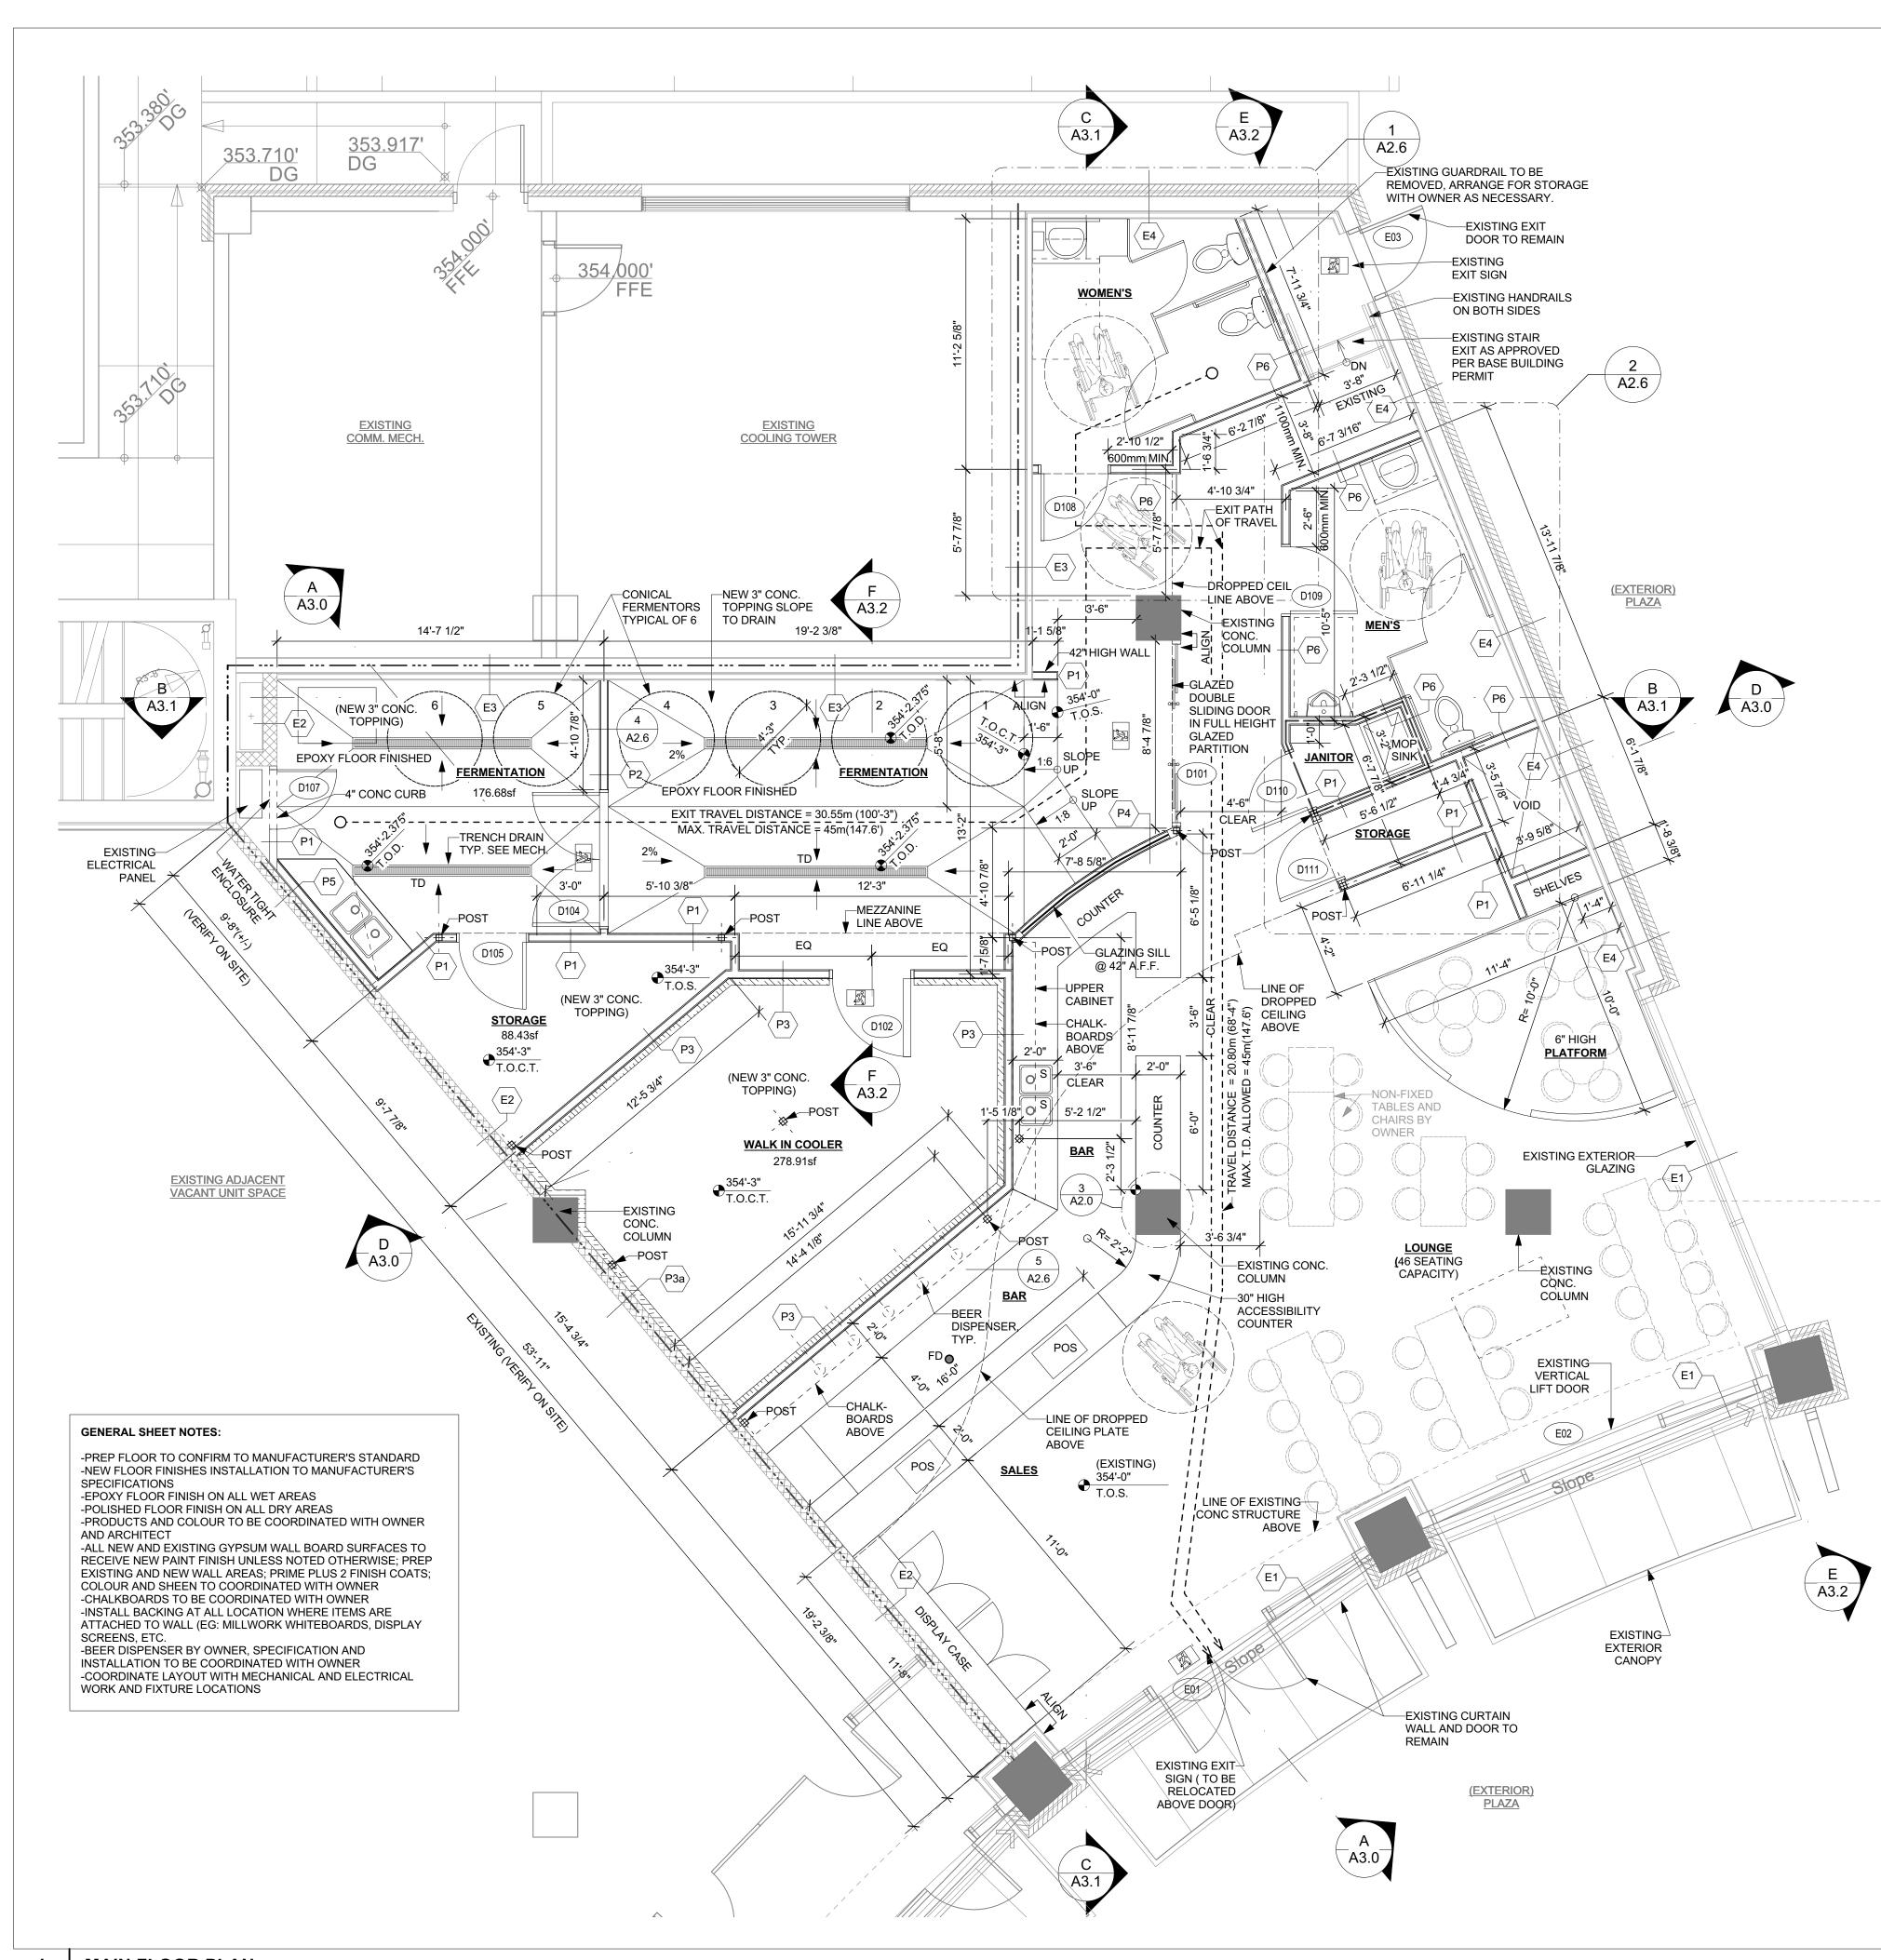

COPYRIGHT:

All drawings, plans, specifications, reports, electronic data files, and working digital records (CAD Files), prepared by or on behalf of SURF Architecture, are Instruments of Service (IOS) and as such are the property of SURF Architecture. The exclusive copyright for SURF Architecture's IOS belongs to SURF Architecture. SURF Architecture's IOS are developed for the exclusive use of its Clients and their authorized Project Team participants. The IOS are to be used exclusively on the particular Project for which they were developed and are

not to be used on any other project work without prior written authorization Due to the unsecured nature of electronic data transfer and the inability of the originator to establish controls over the use thereof, SURF Architecture assumes no responsibility for any damages, errors or omissions, consequential or otherwise, arising from such use. Hard copy IOS take

precedence over electronic data file IOS. In the event that SURF Architecture's IOS are used for purposes other than intended, or if the IOS are amended, altered or revised in any manner whatsoever, without receiving SURF Architecture's prior written consent, anyone improperly using this information does so at their own risk.

Accessing the IOS provided, confirms acceptance of all conditions of use and the user agrees to indemnify, hold harmless and defend SURF Architecture from and against all claims, demands, losses, damages, liability and costs (including costs between solicitor and user) arising from

COPYRIGHT © 2019 SURF Architecture

PROFESSIONAL SEAL:

FIRE & SMOKE SEPARATIONS

---- - 2 HOUR —— -- — 1 1/2 HOUR — - — 1 HOUR

———— 3/4 HOUR —— SMOKE SEPARATION (S.S.) (NO

EXIT PATH

EXIT SIGN

FEB. 08, 2021 REZONING AMENDMENT APP. PRELIMINARY REVIEW DATE DESCRIPTION ISSUES

ARCHITECTURE

#204 -1281 JOHNSTON RD. WHITE ROCK, BC V4B 3Y9 TEL: 604.616.0646 email: mark@surfarchitecture.com

www.surfarchitecture.com

3 DOGS BREWING

3 DOGS BREWING TENANT IMPROVEMENT

PROJECT ADDRESS: UNIT#107 15181 THRIFT AVENUE WHITE ROCK, BC V4B 3Z4

DRAWING TITLE: MAIN FLOOR PLAN

PROJECT NO: 2020-08 DRAWN BY: CHECKED BY DATE: NOV. 18, 2020

SCALE: **AS SHOWN** 

**REVISION NO:** DRAWING NO

**KEY PLAN** A1.0 | SCALE: 1" = 50'-0"

**MAIN FLOOR PLAN** A1.0 SCALE: 1/4" = 1'-0"

(NEW WALL)

PARTITION - NON-RATED (NON-LOADBEARING) 5/8" GYPSUM WALL BOARD, 3-5/8" STEEL STUDS @ 24" O.C. 5/8" GYPSUM WALL BOARD


- P2 PARTITION (FULL HEIGHT) NON-RATED (NON-LOADBEARING)(SEE STRUCTURAL) 5/8" GYPSUM WALL BOARD 3-5/8" STEEL STUDS @ 24" O.C. 5/8" GYPSUM WALL BOARD
- P3 COOLER INSULATED PARTITION NON-RATED (NON-LOADBEARING) 5/8" GYPSUM WALL BOARD - PAINTED 3 5/8" STEEL STUDS COOLER INSULATED PANELS (BY MANUFACTURER)
- P3a COOLER INSULATED PARTITION NON-RATED (NON-LOADBEARING) COOLER INSULATED PANELS BY MANUFACTURER 1-1/2" FURRING CHANNEL EXISTING 8" CMU WALL
- P4 PARTITION (42" HIGH A.F.F.) NON-RATED 5/8" GYPSUM WALL BOARD 3-5/8" STEEL STUD @ 16" O.C. 5/8" GYPSUM WALL BOARD
- P5 FURRING 5/8" GYPSUM WALL BOARD 1-1/2" FURRING CHANNEL @ 16" O.C. 5/8" GYPSUM WALL BOARD EXISTING 8" CMU WALL
- PARTITION NON-RATED (NON-LOADBEARING) (ACOUSTIC SEPARATION, WET AREA ON 1 SIDE) 5/8" GYPSUM WALL BOARD 3-5/8" STEEL STUD @ 24" O.C. ACOUSTIC BATT INSULATION IN CAVITY 5/8" CEMENT BOARD FRP (FIBER-REINFORCED PANEL) TO TOP OF DOOR FRAME HEIGHT

EXISTING WALLS
(PER BASE BUILDING ARCH PARTITION SCHEDULE)


- E1 EXISTING CURTAIN WALL SYSTEM
- E2 EXISTING FIRE RATED DEMISING WALL: (2HR) 8" CONCRETE MASONRY UNITS
- E3 EXISTING FIRE RATED DEMISING WALL: (2HR) 5/8" TYPE "X" GWB 3 5/8" STEEL STUDS @ 24" O.C. BATT INSULATION IN CAVITIES 1" AIR SPACE 8" CONCRETE WALL
- E4 EXISTING EXTERIOR WALL: 5/8" TYPE "X" GWB 2 1/2" STEEL STUDS @ 24" O.C. BATT INSULATION IN CAVITIES 1" AIR SPACE 8" CONCRETE WALL RIGID INSULATION RAIN SCREEN EXTERIOR CLADDING

(FLOOR/CEILING ASSEMBLY)

- F1 POLISHED CONC. FLOOR FINISH 2" CONCRETE TOPPING 2" REVEAL "Q" DECK
- F2 2" CONCRETE TOPPING 2" REVEAL "Q" DECK FURRING CHANNEL 5/8" GYPSUM WALL BOARD
- F3 POLISHED CONC. FLOOR FINISH 2" CONCRETE TOPPING 2" REVEAL QDECK 3 1/2" INSULATED COOLER PANEL BY MANUFACTURER

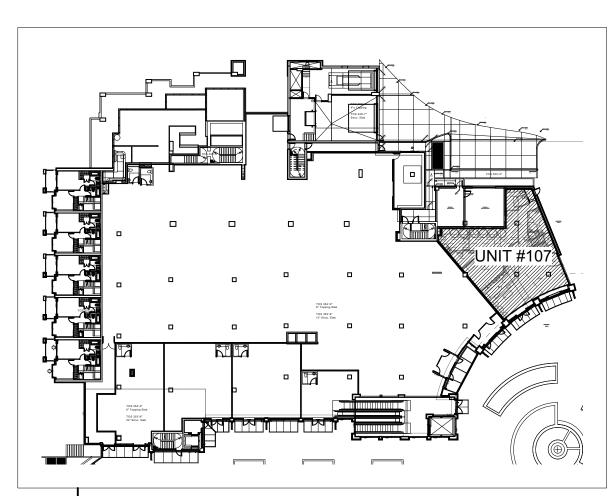


KEY PLAN A1.0 SCALE: 1" = 50'-0"

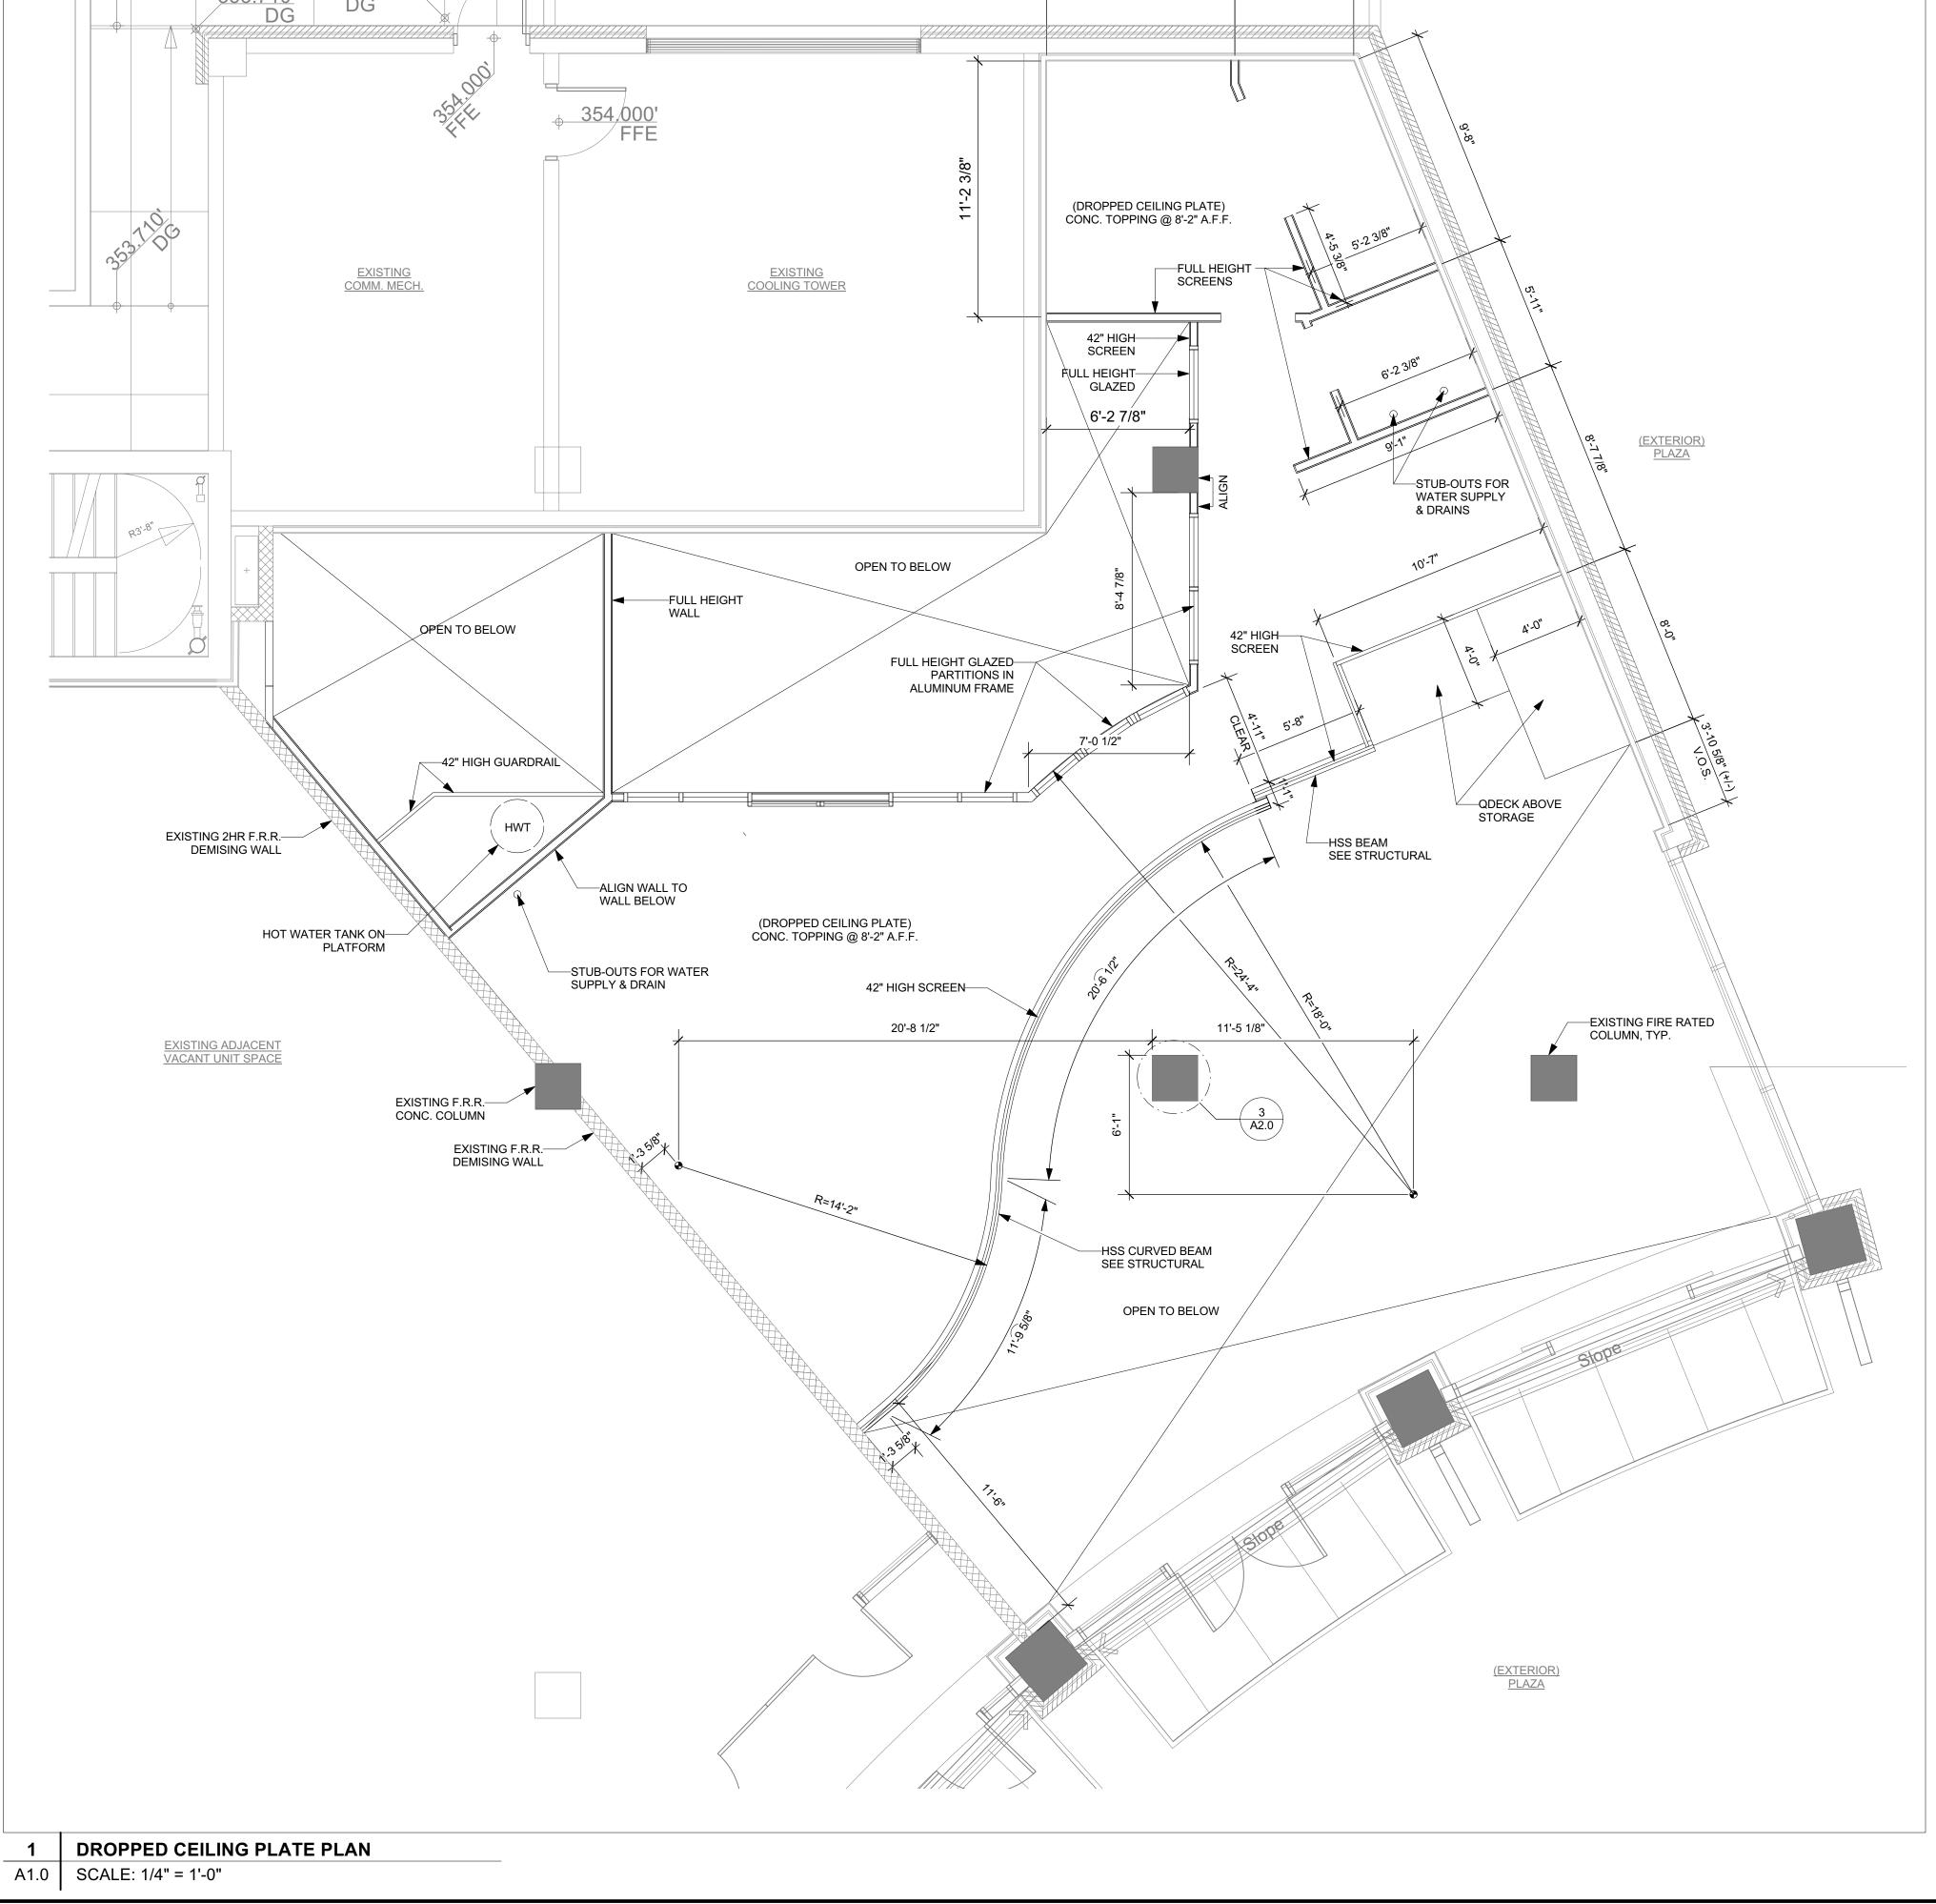

8'-2 3/4"

5'-2 3/8"

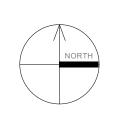

COPYRIGHT:

NORTH:

All drawings, plans, specifications, reports, electronic data files, and working digital records (CAD Files), prepared by or on behalf of SURF Architecture, are Instruments of Service (IOS) and as such are the property of SURF Architecture. The exclusive copyright for SURF Architecture's IOS belongs to SURF Architecture.
SURF Architecture's IOS are developed for the exclusive use of its Clients and their authorized Project Team participants. The IOS are to be used exclusively on the particular Project for which they were developed and are

not to be used on any other project work without prior written authorization

of SURF Architecture.

Due to the unsecured nature of electronic data transfer and the inability of the originator to establish controls over the use thereof, SURF Architecture assumes no responsibility for any damages, errors or omissions, consequential or otherwise, arising from such use. Hard copy IOS take precedence over electronic data file IOS.

In the event that SURF Architecture's IOS are used for purposes other than intended, or if the IOS are amended, altered or revised in any manner whatsoever, without receiving SURF Architecture's prior written consent,

COPYRIGHT © 2019 SURF Architecture

anyone improperly using this information does so at their own risk.

Accessing the IOS provided, confirms acceptance of all conditions of use and the user agrees to indemnify, hold harmless and defend SURF Architecture from and against all claims, demands, losses, damages, liability and costs (including costs between solicitor and user) arising from

PROFESSIONAL SEAL:

FIRE & SMOKE SEPARATIONS

---- - 2 HOUR —— -- — 1 1/2 HOUR

— - — 1 HOUR ———— 3/4 HOUR —— SMOKE SEPARATION (S.S.) (NO

> EXIT PATH EXIT SIGN

2 FEB. 08, 2021 REZONING AMENDMENT APP. PRELIMINARY REVIEW DATE DESCRIPTION ISSUES

## ARCHITECTURE

#204 -1281 JOHNSTON RD. WHITE ROCK, BC V4B 3Y9 TEL: 604.616.0646 email: mark@surfarchitecture.com www.surfarchitecture.com

3 DOGS BREWING

3 DOGS BREWING TENANT IMPROVEMENT

PROJECT ADDRESS: UNIT#107 15181 THRIFT AVENUE WHITE ROCK, BC V4B 3Z4

DRAWING TITLE: DROPPED CEILING PLATE

PROJECT NO: 2020-08 DRAWN BY: CHECKED BY: DATE: NOV. 18, 2020 SCALE: **AS SHOWN** 

REVISION NO: DRAWING NO

F3 POLISHED CONC. FLOOR FINISH


3 1/2" INSULATED COOLER PANEL BY

A1.0 | SCALE: 1/4" = 1'-0"

2" CONCRETE TOPPING

2" REVEAL QDECK

MANUFACTURER

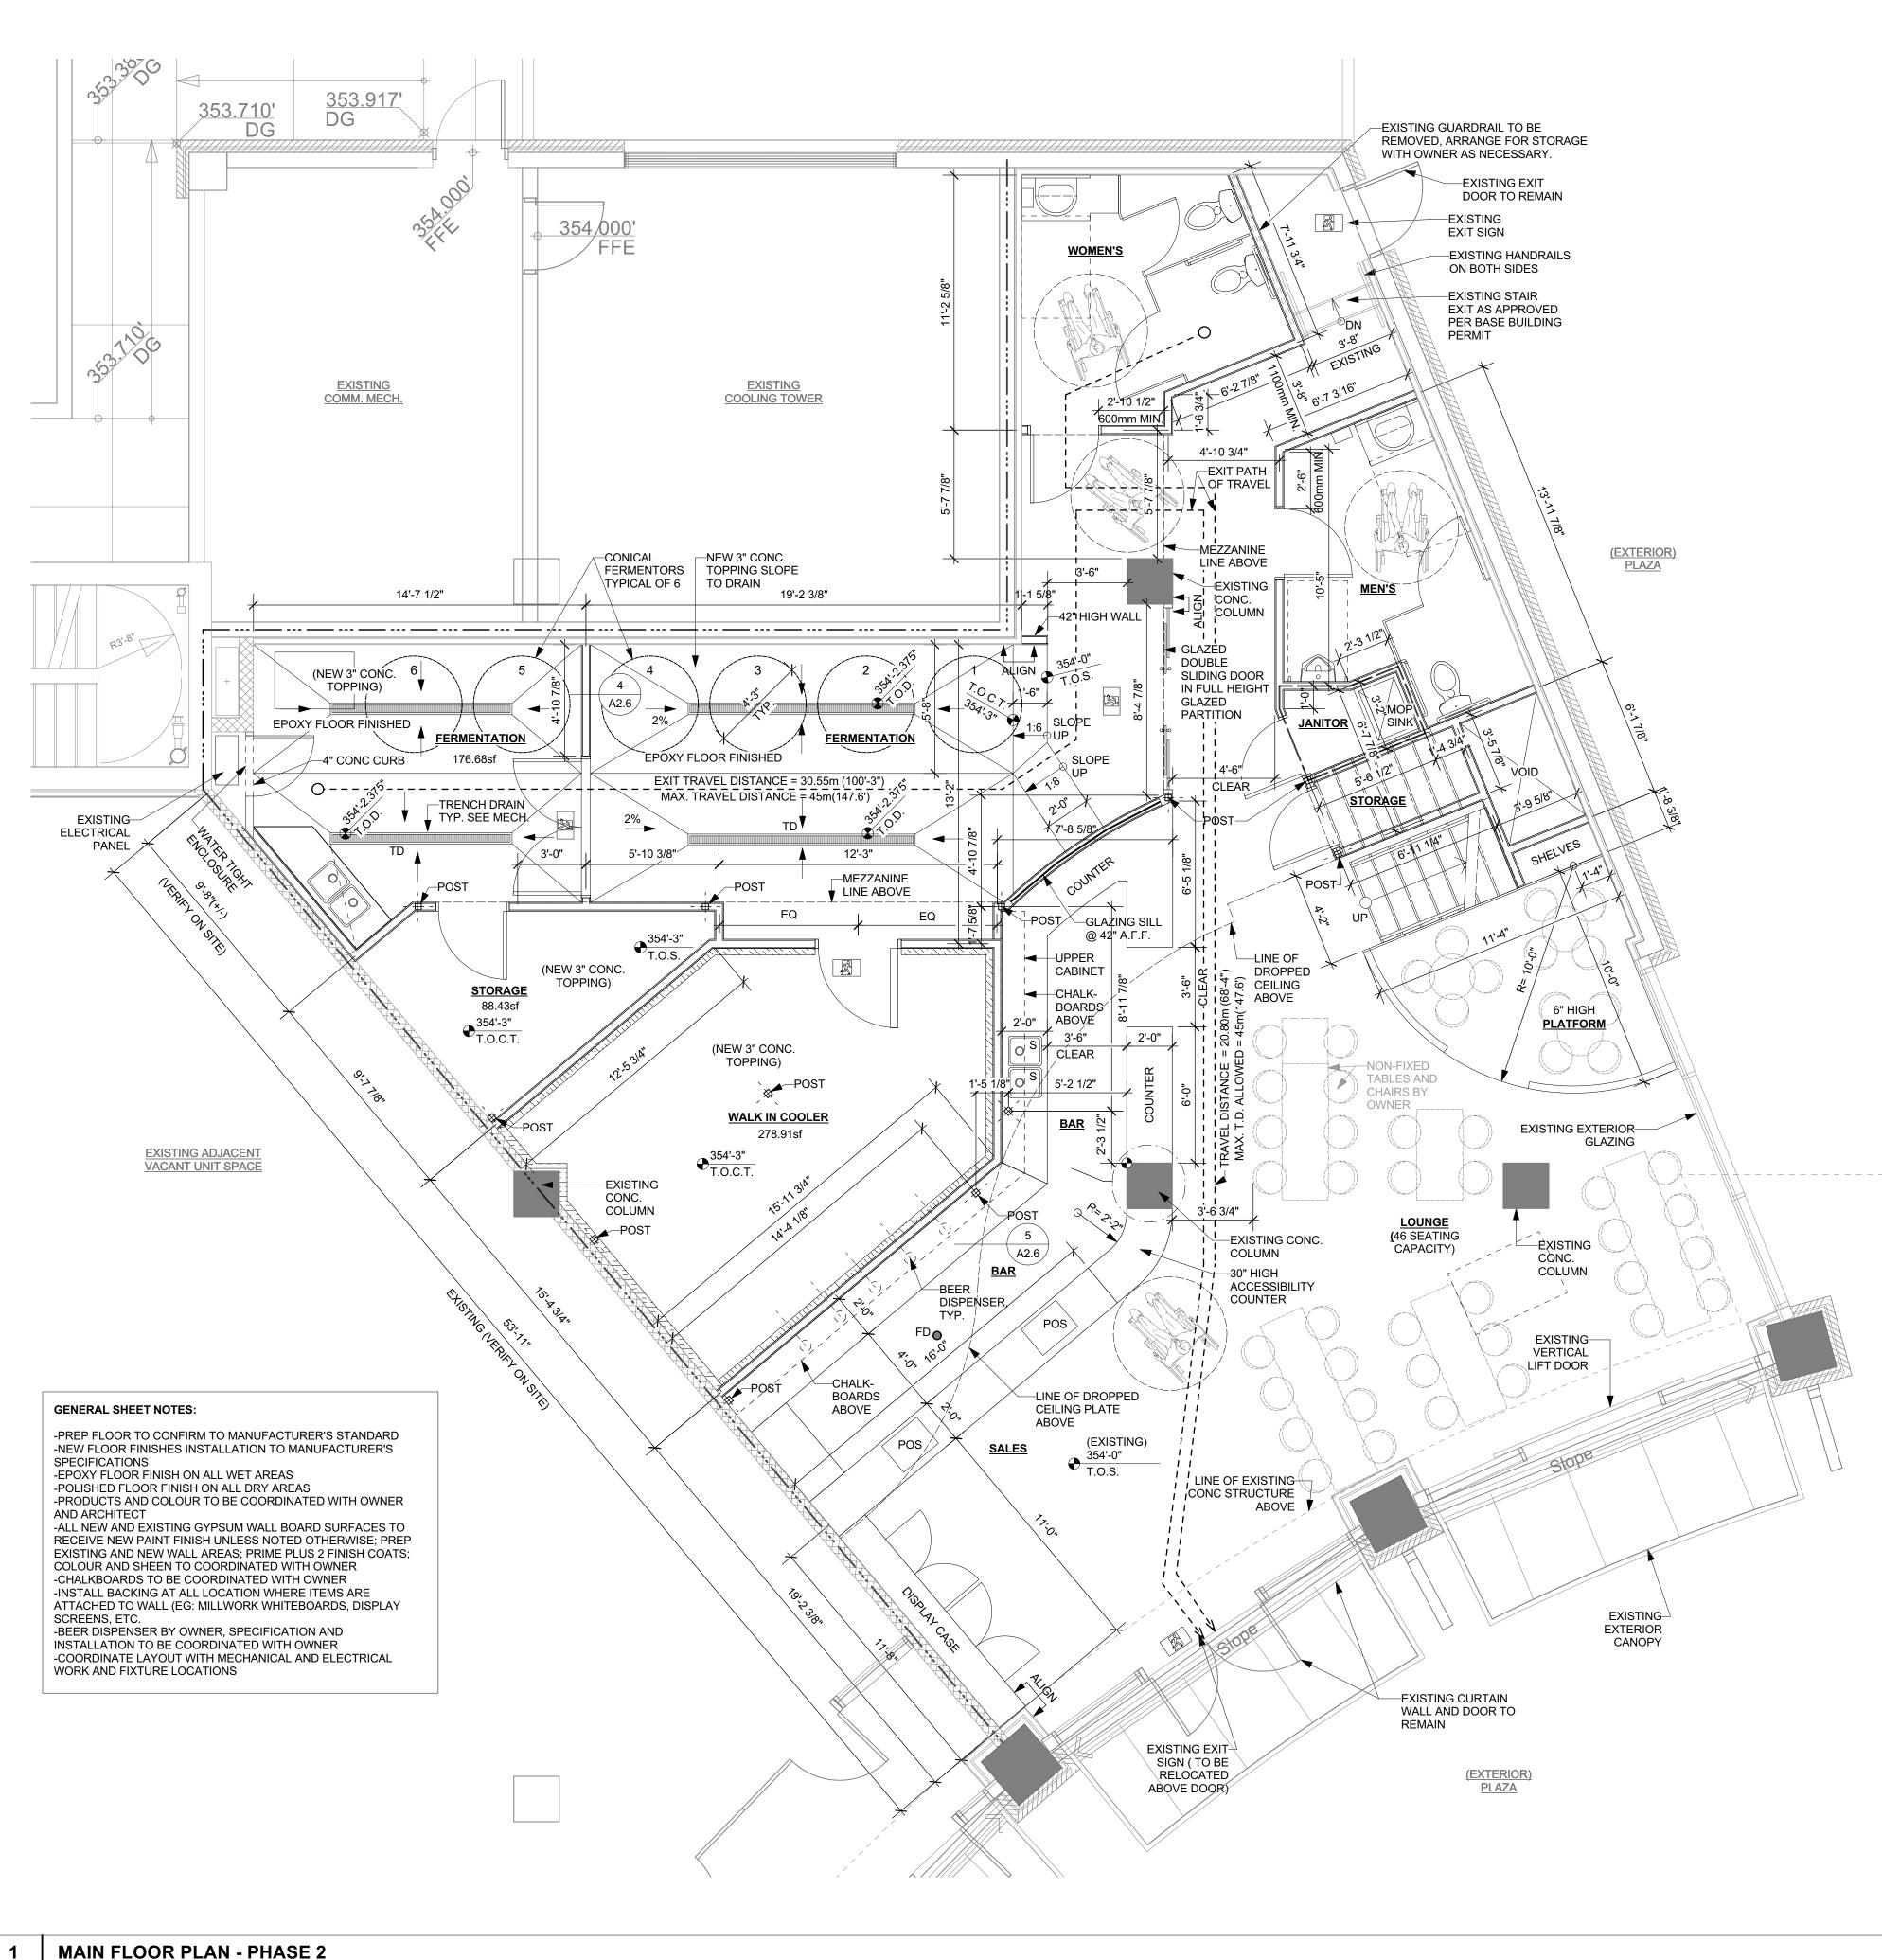

NORTH

COPYRIGHT:

NORTH:

All drawings, plans, specifications, reports, electronic data files, and working digital records (CAD Files), prepared by or on behalf of SURF Architecture, are Instruments of Service (IOS) and as such are the property of SURF Architecture. The exclusive copyright for SURF Architecture's IOS belongs to SURF Architecture.

SURF Architecture's IOS are developed for the exclusive use of its Clients and their authorized Project Team participants. The IOS are to be used exclusively on the particular Project for which they were developed and are

not to be used on any other project work without prior written authorization of SURF Architecture.

Due to the unsecured nature of electronic data transfer and the inability of the originator to establish controls over the use thereof, SURF Architecture assumes no responsibility for any damages, errors or omissions, consequential or otherwise, arising from such use. Hard copy IOS take precedence over electronic data file IOS.

precedence over electronic data file IOS. In the event that SURF Architecture's IOS are used for purposes other than intended, or if the IOS are amended, altered or revised in any manner whatsoever, without receiving SURF Architecture's prior written consent, anyone improperly using this information does so at their own risk. Accessing the IOS provided, confirms acceptance of all conditions of use and the user agrees to indemnify, hold harmless and defend SURF Architecture from and against all claims, demands, losses, damages, liability and costs (including costs between solicitor and user) arising from

COPYRIGHT © 2019 SURF Architecture

PROFESSIONAL SEAL:

FIRE & SMOKE SEPARATIONS

1 HOUR 3/4 HOUR

EXIT PATH
EXIT SIGN

2 FEB. 08, 2021 ISSUED FOR REZONING AMENDMENT APP.

1 JAN. 11, 2021 PRELIMINARY REVIEW

NO. DATE DESCRIPTION

ISSUES

## SURF

#204 -1281 JOHNSTON RD.
WHITE ROCK, BC V4B 3Y9
TEL: 604.616.0646
email: mark@surfarchitecture.com
www.surfarchitecture.com

CLIENT

3 DOGS BREWING

ROJECT:

3 DOGS BREWING TENANT IMPROVEMENT

PROJECT ADDRESS:
UNIT#107
15181 THRIFT AVENUE
WHITE ROCK, BC V4B 3Z4

DRAWING TITLE:

MAIN FLOOR PLAN
W/ MEZZANINE

PROJECT NO:

2020-08

DRAWN BY: CHECKED BY:

LC MK

DATE:

NOV. 18, 2020

SCALE:

AS SHOWN

REVISION NO:

DRAWING NO:

42.2

E1 EXISTING CURTAIN WALL SYSTEM


E2 EXISTING FIRE RATED DEMISING WALL: (2HR) 8" CONCRETE MASONRY UNITS


E3 EXISTING FIRE RATED DEMISING WALL: (2HR) 5/8" TYPE "X" GWB 3 5/8" STEEL STUDS @ 24" O.C. BATT INSULATION IN CAVITIES 1" AIR SPACE 8" CONCRETE WALL

E4 EXISTING EXTERIOR WALL: 5/8" TYPE "X" GWB 2 1/2" STEEL STUDS @ 24" O.C. BATT INSULATION IN CAVITIES 1" AIR SPACE 8" CONCRETE WALL RIGID INSULATION RAIN SCREEN EXTERIOR CLADDING

(FLOOR/CEILING ASSEMBLY) F1 POLISHED CONC. FLOOR FINISH

A1.0 | SCALE: 1/4" = 1'-0"

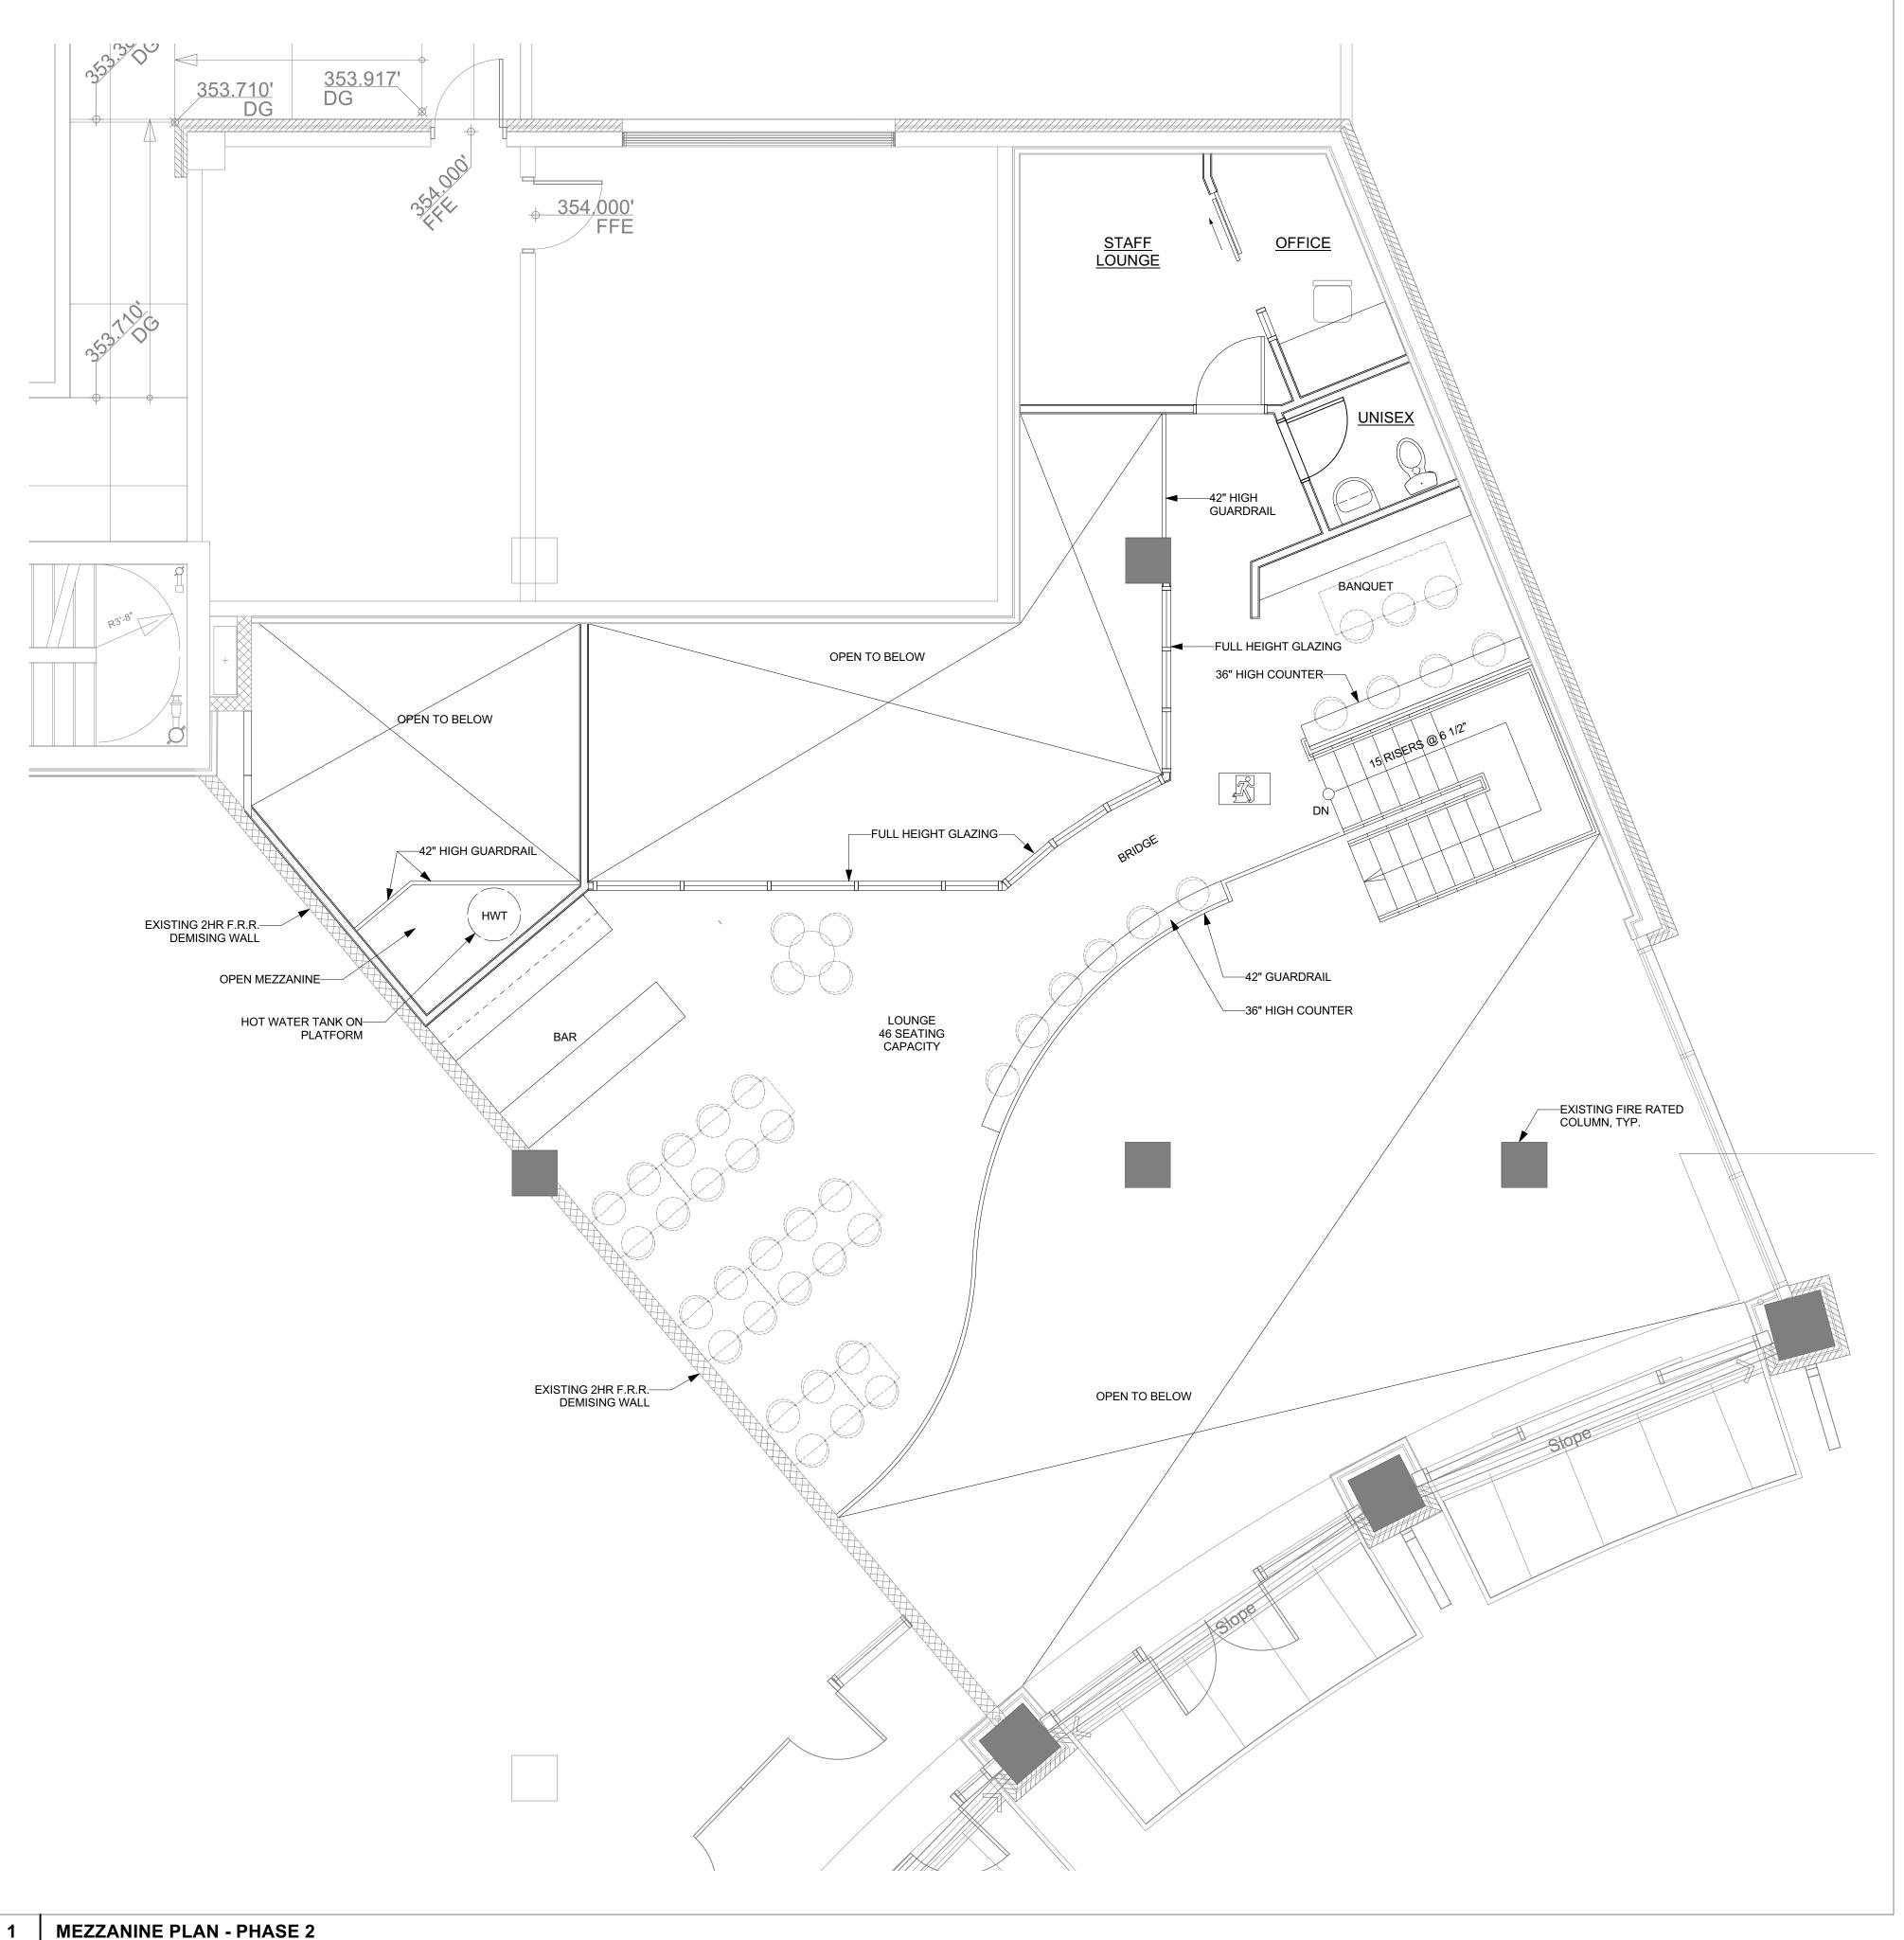

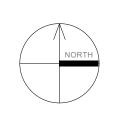

COPYRIGHT:

NORTH:

All drawings, plans, specifications, reports, electronic data files, and working digital records (CAD Files), prepared by or on behalf of SURF Architecture, are Instruments of Service (IOS) and as such are the property of SURF Architecture. The exclusive copyright for SURF Architecture's IOS belongs to SURF Architecture.

SURF Architecture's IOS are developed for the exclusive use of its Clients and their authorized Project Team participants. The IOS are to be used exclusively on the particular Project for which they were developed and are

not to be used on any other project work without prior written authorization of SURF Architecture.

Due to the unsecured nature of electronic data transfer and the inability of Due to the unsecured nature of electronic data transfer and the inability of the originator to establish controls over the use thereof, SURF Architecture assumes no responsibility for any damages, errors or omissions, consequential or otherwise, arising from such use. Hard copy IOS take precedence over electronic data file IOS.

In the event that SURF Architecture's IOS are used for purposes other than intended, or if the IOS are amended, altered or revised in any manner whatsoever, without receiving SURF Architecture's prior written consent, anyone improperly using this information does so at their own risk. Accessing the IOS provided, confirms acceptance of all conditions of use and the user agrees to indemnify, hold harmless and defend SURF

COPYRIGHT © 2019 SURF Architecture

and the user agrees to indemnify, hold harmless and defend SURF Architecture from and against all claims, demands, losses, damages, liability and costs (including costs between solicitor and user) arising from

PROFESSIONAL SEAL:


FIRE & SMOKE SEPARATIONS

---- - 2 HOUR —— -- — 1 1/2 HOUR

— - — 1 HOUR ———— 3/4 HOUR SMOKE SEPARATION (S.S.) (NO RATING)

EXIT PATH

EXIT SIGN

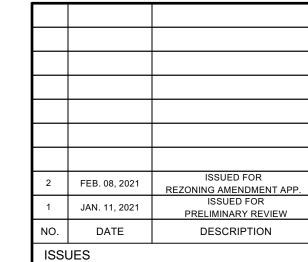

## ARCHITECTURE

#204 -1281 JOHNSTON RD. WHITE ROCK, BC V4B 3Y9 TEL: 604.616.0646 email: mark@surfarchitecture.com www.surfarchitecture.com

3 DOGS BREWING

3 DOGS BREWING

TENANT IMPROVEMENT

PROJECT ADDRESS:

UNIT#107 15181 THRIFT AVENUE WHITE ROCK, BC V4B 3Z4

DRAWING TITLE: MEZZANINE PLAN

PROJECT NO: 2020-08 DRAWN BY: CHECKED BY: DATE: NOV. 18, 2020 SCALE: AS SHOWN