COPYRIGHT:

NORTH:

All drawings, plans, specifications, reports, electronic data files, and working digital records (CAD Files), prepared by or on behalf of SURF Architecture, are Instruments of Service (IOS) and as such are the property of SURF Architecture. The exclusive copyright for SURF Architecture's IOS belongs to SURF Architecture.

SURF Architecture's IOS are developed for the exclusive use of its Clients and their authorized Project Team participants. The IOS are to be used exclusively on the particular Project for which they were developed and are not to be used on any other project work without prior written authorization of SURF Architecture.

Due to the unsecured nature of electronic data transfer and the inability of the originator to establish controls over the use thereof, SURF Architecture assumes no responsibility for any damages, errors or omissions, consequential or otherwise, arising from such use. Hard copy IOS take precedence over electronic data file IOS.

In the event that SURF Architecture's IOS are used for purposes other than intended, or if the IOS are amended, altered or revised in any manner whatsoever, without receiving SURF Architecture's prior written consent, anyone improperly using this information does so at their own risk.

Accessing the IOS provided, confirms acceptance of all conditions of use and the user agrees to indemnify, hold harmless and defend SURF Architecture from and against all claims, demands, losses, damages, liability and costs (including costs between solicitor and user) arising from

COPYRIGHT © 2023 SURF Architecture

such use.

PROFESSIONAL SEAL:

FIRE & SMOKE SEPARATIONS

---- 2 HOUR --- 1 1/2 HOUR

1 HOUR

———— 3/4 HOUR SMOKE SEPARATION (S.S.) (NO RATING)

→ - - → EXIT PATH

EXIT SIGN

6.16.1 Permitted Uses:

The following uses are permitted in one (1) or more principal buildings: 1) retail service group 1 uses;

2) subject to section 9 b), licensed establishments, including liquor primary, food primary, liquor store, agent store, u-brew, u-vin, and licensed manufacturer;

3) hotel;

4) civic use;

5) medical or dental clinic;


6) multi-unit residential use;

7) accessory home occupation in conjunction with a multi-unit residential use and in accordance with the provisions of Section 5.3, and that does not involve clients of the home occupation accessing the building in person;

8) one-unit residential use accessory to a retail service group 1 use and limited to a storey above the portion of a building used for the retail service group 1 use.

ZONING BY LAW

LOCATION MAP N.T.S.

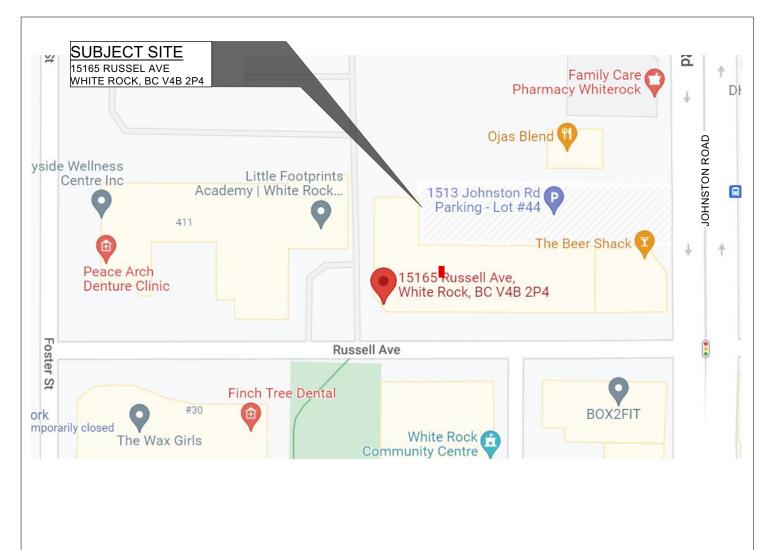

2023-02-09 RESUBMITTED FOR BP 2023-01-12 SUBMITTED FOR BUILDING PERMIT 2022-12-16 APPLICATION DATE DESCRIPTION ISSUES

ARCHITECTURE

#304 -1493 FOSTER STREET WHITE ROCK, BC V4B 3W7 TEL: 604.616.0646 email: mark@surfarchitecture.com www.surfarchitecture.com

GALAXIE CRAFT BREWHOUSE

PROJECT: GALAXI BREWING UPTOWN LOUNGE

PROJECT ADDRESS: 15165 RUSSEL AVE WHITE ROCK B,C. V4B 2P4

DRAWING TITLE:

SITE PLAN INFORMATION

PROJECT NO: 2022 21 DRAWN BY:

CHECKED BY:

DATE: 2022-12-16

SCALE: AS SHOWN

NA

REVISION NO: DRAWING NO:

A1.0

SITE PLAN - EXISTING SCALE: 1/16" = 1"

SURVEY INFORMATION OPTAINED FROM TOPOGRAPHIC SURVEY FOR P.I.D 006-760-481 PROPOSED BY: ONDERWATER LAND SURVEYING DATED: 04-JAN-2023

GENERAL NOTES

1.0 ASSURANCE / COMPLIANCE REQUIREMENTS

THE CURRENT BRITISH COLUMBIA BUILDING CODE 2018 SHALL FORM AN INTEGRAL PART OF THESE

- 1.1 DRAWINGS. ALL CONSTRUCTION MATERIALS & PROCEDURES SHALL CONFORM TO THESE STANDARDS. 1.2 ALL WORK TO CONFORM TO LOCAL BYLAWS AND DEVELOPMENT PERMIT REQUIREMENTS.
- ALL DRAWINGS ARE TO BE READ AS A COMPLETE SET IN CONJUNCTION WITH, MECHANICAL, 1.3 ELECTRICAL & INTERIOR DESIGN DRAWINGS.
- ALL WORK WILL BE SUBJECT TO FIELD REVIEW BY THE ARCHITECT OR OTHER REGISTERED PROFESSIONALS AND BY THE CONSULTING ENGINEERS NAMED ON THESE DRAWINGS IN ORDER TO
- 1.4 MEET THE MUNICIPAL LETTERS OF ASSURANCE / COMPLIANCE REQUIREMENTS.
- 1.5 ALL WORK MUST MEET THE APPROVAL OF THE PROFESSIONAL CONSULTANTS. ALL WORK MUST MEET THE STANDARDS OF THE B.C. TRADE ASSOCIATIONS GOVERNING EACH TRADE
- 1.6 INVOLVED ON THE PROJECT. STARTING WORK ON THIS PROJECT BY ANY SUB-CONTRACTOR MEANS THAT THE ABOVE
- 1.7 FORWARD TO MEET THE PROFESSIONAL CONSULTANTS FIELD REVIEW REQUIREMENTS. THE SUB-CONTRACTORS ARE RESPONSIBLE FOR SITE SAFETY AND MEETING ALL REQUIREMENTS OF
- 1.8 WORKSAFE BC. THE GENERAL CONTRACTOR IS TO KEEP RECORD AND PROVIDE THE ARCHITECT AND OWNER WITH 1.9 COPIES OF ALL MUNICIPAL INSPECTION SLIPS.

REQUIREMENTS HAVE BEEN REVIEWED AND THAT NO CLAIMS FOR ADDITIONAL COSTS WILL BE PUT

- THE SUB-CONTRACTOR IS TO CHECK ALL DIMENSIONS AFFECTING HIS TRADE AND IN THE CASE OF
- 1.10 ANY DISCREPANCIES, THE CONSTRUCTION MANAGER IS TO BE NOTIFIED BEFORE WORK COMMENCES. ALL DIMENSIONS ARE FROM THE INTERIOR FACE OF SUITE DEMISING WALLS AND EXPOSED
 - CONCRETE EXTERIOR PERIMETER WALLS. INTERIOR PARTITIONS ARE DIMENSIONED FROM CENTRE TO CENTRE OF WALL UNLESS NOTED AS SUCH IN THE ASSEMBLY SCHEDULE. DO NOT SCALE
 - THE CONSTRUCTION MANAGER IS TO CHECK ALL DIMENSIONS AND VERIFY THE LOCATION OF 2.2 EXISTING SUITE DEMISING WALLS.
 - IN THE CASE OF ANY DIMENSIONAL DISCREPANCIES, THE ARCHITECT IS TO BE NOTIFIED BEFORE
- 2.3 COMMENCEMENT OF WORK. 3.0 ASSEMBLIES

REFER TO FLOOR PLANS FOR ASSEMBLY DESIGNATION OF WALL (W), PARTITION (P), SHAFT WALL 3.1 (SW) AND FURRING (F) TYPES.

- SEAL ALL EDGE CONDITIONS AT TOP, BOTTOM AND SIDES OF PARTITIONS AS WELL AS AROUND 3.2 PARTITION PENETRATIONS TO MEET F.R.R. AND STC REQUIREMENTS ASSIGNED TO THE ASSEMBLY.
- ALL EXPOSED AND FINISHED GYPSUM WALL BOARD TO BE FINISHED TO INDUSTRY STANDARD GA-214-3.3 96, "RECOMMENDED LEVELS OF GYPSUM BOARD FINISH, LEVEL 5.
- THE PREFIX "X" FOR WALL, DESIGNATES THE ASSEMBLY WITH AS A FIRE SEPARATION WITH A FIRE 3.4 RESISTANCE RATING.
- CONTRACTOR TO CONFIRM ALL INTERIOR STEEL STUD SIZING, GAUGE, AND DEFLECTION DETAIL 3.5 REQUIREMENTS PER B.C.B.C. 2018 REQUIREMENTS.
- USE MOISTURE RESISTANT GYPSUM WALL BOARD ON PAINT FINISH ASSEMBLIES IN WASHROOMS, 3.6 CHANGE ROOMS, AND JANITOR'S CLOSETS. SOUND TRANSMISSION CLASSIFICATION (STC) AND IMPACT INSULATION CLASS (IIC) ARE TO MEET
- OR EXCEED REQUIREMENTS PER B.C.B.C. 2018 OR THOSE STIPULATED WITHIN THE ASSEMBLY 3.7 SCHEDULE (THE MORE STRINGENT OF WHICH IS TO GOVERN). (SEE NOTE 2.2)
- REFER TO FLOOR PLAN FOR EXTENT OF PARTITION TYPE WHERE THERE IS A COMBINATION OF MORE 3.8 THAN ONE TYPE OF PARTITION.
- 3.9 VERIFY EXISTING CONDITIONS TO CONFIRM FOR TYPE AND SPECIFICATION OF WALL ASSEMBLIES.
- 4.1 FIRESTOPPING TO CONFORM TO CAN4-S115 STANDARD.
 - 4.2 INSTALL FIRESTOP TO ALL WALLS TO PREVENT FIRE FROM ENTERING JOIST SPACES.
 - FIRESTOPPING SYSTEMS ARE TO BE SUBMITTED FOR REVIEW AND APPROVAL PRIOR TO 4.3 INSTALLATION.
 - 4.4 PROVIDE FIRE STOPPING TO ALL ASSEMBLY PENETRATIONS. REFER TO ELECTRICAL TRADE DRAWINGS FOR HEAT RISE & SMOKE DETECTOR LOCATIONS, EXIT
- 4.5 SIGNAGE AND LIGHTING.

5.0 FIRE SAFETY PLAN:

5.1 FIRE SAFETY PLAN IS TO BE PROVIDED IN CONFORMANCE WITH JURISTICTIONAL REQUIREMENTS.

- 6.1 REFER TO CONSTRUCTION ASSEMBLIES.
- 6.2 ALL INTERIOR PARTITIONS TO BE 3-5/8" STEEL STUDS. UNLESS NOTED OTHERWISE.
- 6.3 STEEL STUD OVER 12'-0" HEIGHT SHALL BE 6" REFER TO STEEL STUD ENGINEER FOR GAUGE 6.4 CONFIRM ROUGH OPENING SIZES PRIOR TO FRAMING.
- PROVIDE SUFFICIENT BLOCKING FOR ALL WALL & CEILING MOUNTED FIXTURES, HANDRAILS, GRAB
- 6.5 BARS & RAILINGS. PROTECT OTHER WOOD MEMBERS IN CONTACT WITH CONCRETE WITH A 45 lb. DAMP PROOFING
- 6.6 COURSE OR A CONTINUOUS POLYETHYLENE GASKET. PROVIDE DEFLECTION TRACK AT THE TOP OF ALL STEEL STUD WALL ASSEMBLIES WHERE ANCHORD
- 6.7 TO THE UNDERSIDE OF BUILDING STRUCTURE. 7.0 MILLWORK:
 - ALL WORK SURFACES, SHELVES, CABINETS, COUNTERS, INTERIOR FINISHES, INTERIOR DOORS, PAINTS, 7.1 ETC..., BY OWNER AND COORDINATED WITH SURF ARCHITECTURE.
 - 7.2 ALL MILLWORK TO BE SEISMICALLY RESTRAINED.
- 8.1 REFER TO DOOR SCHEDULE.
- 8.2 HARDWARE & KEYING SCHEDULE TO BE PROVIDED BY HARDWARE SUPPLIER.
- 8.3 ALL DOORS TO HAVE LEVER TYPE HANDLES.
 - 9.1 ALL GLASS IN DOORS SHALL BE TEMPERED SAFETY GLASS.
 - 9.2 REFER TO DOORS AND WINDOWS SCHEDULE.
 - SAFETY GLASS OF THE LAMINATED OR TEMPERED TYPE TO CONFORM TO CAN/CGSB-12.1-M, 9.3 "TEMPERED OR LAMINATED SAFETY GLASS".
 - 9.4 WIRED GLASS TO CONFORM TO CAN/CGSB-12.11M, "WIRED SAFETY GLASS".
- 10.0 FINISHES: PROVIDE WATER RESISTANT MOUNTING SURFACES FOR ALL CERAMIC TILED SURFACES. 5/8" TYPE 'X'

GWB TO BE CONTINUOUS BEHIND WATER RESISTANT BOARDS TO MAINTAIN FIRE RATED ASSEMBLY 10.1 WHERE ADJACENT TO EXISTING RATED WALL.

10.2 FLAME SPREAD RATING FOR INTERIOR FINISHES TO CONFORM TO B.C.B.C. 2018 REQUIREMENTS. 10.3 FINISHES TO BE SELECTED BY OWNER AND TO BE COORDINATED WITH SURF ARCHITECTURE

11.0 SIGNAGE:

11.1 SIGNAGE REQUIREMENTS PER INTERNATIONAL SYMBOL OF ACCESS. 12.0 FIXTURES

12.1 REFER TO ELECTRICAL AND MECHANICAL DOCUMENTS.

12.2 PLUMBING HARDWARE TO BE LEVER TYPE IN COMPLIANCE WITH BCBC 2018. REFER TO MECHANICAL DRAWINGS FOR BATHROOM ACCESSORIES & TO BE COORDINATED WITH

SURF ARCH.

LETTER OF ASSURANCE NOTES:

SUPPORTING REGISTERED PROFESSIONALS REQUIRED TO PROVIDE THE REGISTERED PROFESSIONAL OF RECORD FOR THAT DISCIPLINE WITH SEALED DESIGN DOCUMENTS, FIELD REVIEW REPORTS OR OTHER APPROPRIATE DOCUMENTATION SUCH AS SCHEDULES S-B AND S-C SHOWING THAT THEY HAVE REVIEWED THE WORK RELATED TO THEIR DESIGN AND HAVE DETERMINED THAT IT SUBSTANTIALLY COMPLIES WITH APPLICABLE CODE REQUIREMENTS AND THEIR DESIGN.

THE CONTRACTOR IS REQUIRED TO INFORM THE COORDINATING REGISTERED PROFESSIONAL IN WRITING IN A FORMAL LETTER IF THERE IS ANY CHANGE IN THE SUPPORTING REGISTERED PROFESSIONAL DURING CONSTRUCTION.

SCHEDULES S-B AND S-C HAVE BEEN DEVELOPED COOPERATIVELY BY THE AIBC AND THE APEGBC FOR USE BY SUPPORTING REGISTERED PROFESSIONALS, AND THEIR USE IS STRONGLY ENCOURAGED. S-B - ASSURANCE OF PROFESSIONAL DESIGN & COMMITMENT FOR FIELD REVIEW BY SUPPORTING REGISTERED

S-C ASSURANCE OF PROFESSIONAL FIELD REVIEW AND COMPLIANCE BY SUPPORTING REGISTERED PROFESSIONAL

ARCHITECTURAL (ONLY CHECKED DOCUMENTS TO BE PROVIDED FOR THIS PROJECT) STRUCTURAL DESIGN FOR GUARDRAILS AND HANDRAILS

WALL CLADDING SYSTEMS

EXTERIOR GLAZING

STRUCTURAL DESIGN FOR CURTAIN WALL SYSTEM (WIND LOAD/SEISMIC)

SEISMIC RESTRAINT OF CEILINGS

SEISMIC RESTRAINT OF LIGHTING

EXISTING BUILDING - MAIN LEVEL (RETAIL SPACES):

COMMON AREA (WASHROOMS, HALLWAYS, JANITOR)

OFF-STREET PARKING REQUIREMENTS FOR THIS T.I.

COMMERCIAL-LICENSED ESTABLISHMENT

UNIT #15165 (GALAXIE BREWIN)

DINING/LOUNGE

OUTDOOR PATIO

BICYCLE PARKING

STRUCTURAL CAPACITY OF ARCHITECTURAL COMPONENTS FOR ANCHORAGE AND SEISMIC RESTRAINT


SOUND CONTROL

PROPRIETARY ROOFING AND FLASHING SYSTEMS

ENERGY MODELING

TESTING COMPLIANCE WITH PART 10- ENERGY EFFICIENCY

DOOR CLOSURE

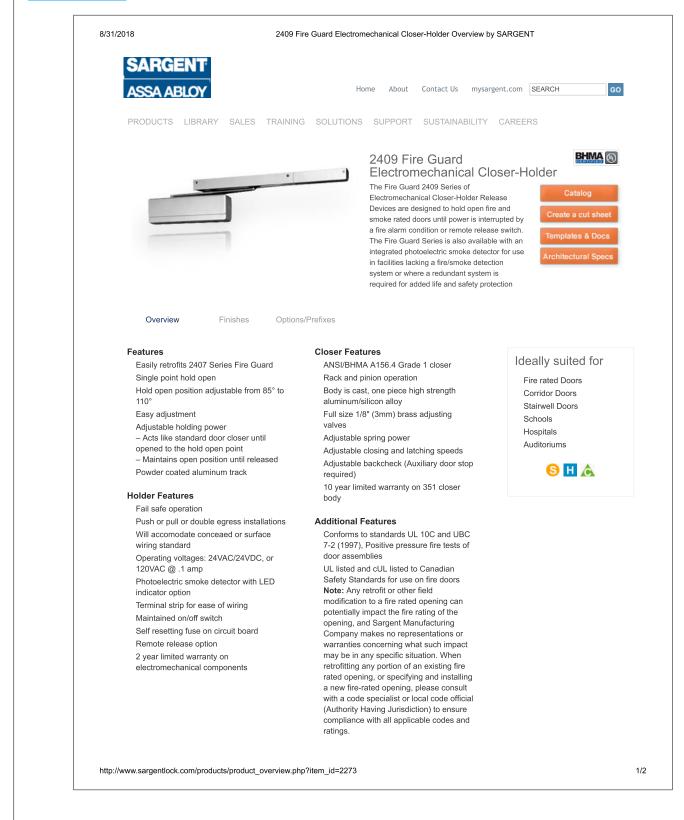

18,906 SF (APPROX.)

2,823.59SF (262.32 sq.m.)

1,757.36SF(163.26sq.m.)

143.43SF(13.33sq.m.)

797.76SF(74.11sq.m.)

2,823.59SF(262.32 sq.m.)

109 SEAT INTERIOR PATRONS


15 SPACES WILL BE ASSIGNED

1 PER EVERY 8 SEATS AVAILABLE FOR CUSTOMER USE:

10 SEATS EXTERIOR PATRONS 119 SEATS / 8 = 14.8 OR (15) SPACES REQUIRED

0.75sq.m. SPACES PER 200 sq.m. OF G.F.A.

262.32/200=1.31 x 0.75sq.m. = 0.98 OR 1 SPACE

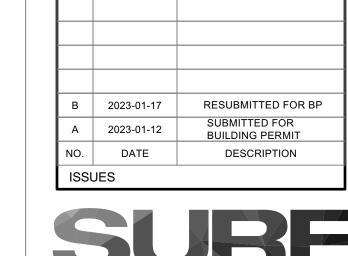

SURF **ARCHITECTURE**

WHITE ROCK, BC V4B 0C4 TEL: 604.616.0646 email: mark@surfarchitecture.com www.surfarchitecture.com

#304 -FOSTER STREET.

NORTH:

COPYRIGHT:

belongs to SURF Architecture.

PROFESSIONAL SEAL:

All drawings, plans, specifications, reports, electronic data files, and

working digital records (CAD Files), prepared by or on behalf of SURF Architecture, are Instruments of Service (IOS) and as such are the property

of SURF Architecture. The exclusive copyright for SURF Architecture's IOS

SURF Architecture's IOS are developed for the exclusive use of its Clients

and their authorized Project Team participants. The IOS are to be used exclusively on the particular Project for which they were developed and are

not to be used on any other project work without prior written authorization

Due to the unsecured nature of electronic data transfer and the inability of

the originator to establish controls over the use thereof, SURF Architecture assumes no responsibility for any damages, errors or omissions, consequential or otherwise, arising from such use. Hard copy IOS take

precedence over electronic data file IOS.
In the event that SURF Architecture's IOS are used for purposes other than

intended, or if the IOS are amended, altered or revised in any manner whatsoever, without receiving SURF Architecture's prior written consent,

anyone improperly using this information does so at their own risk.

Accessing the IOS provided, confirms acceptance of all conditions of use

liability and costs (including costs between solicitor and user) arising from

and the user agrees to indemnify, hold harmless and defend SURF Architecture from and against all claims, demands, losses, damages,

COPYRIGHT © 2023 SURF Architecture

GALAXIE CRAFT BREWHOUSE

GALAXIE BREWING

UPTOWN LOUNGE

PROJECT ADDRESS: 15165 RUSSEL AVE WHITE ROCK B,C. V4B 2P4


DRAWING TITLE: **GENERAL NOTES**


PROJECT NO: 2022-21 DRAWN BY: CHECKED BY: MK DATE: DEC 16, 2022

SCALE: **AS SHOWN**

REVISION NO:

DRAWING NO

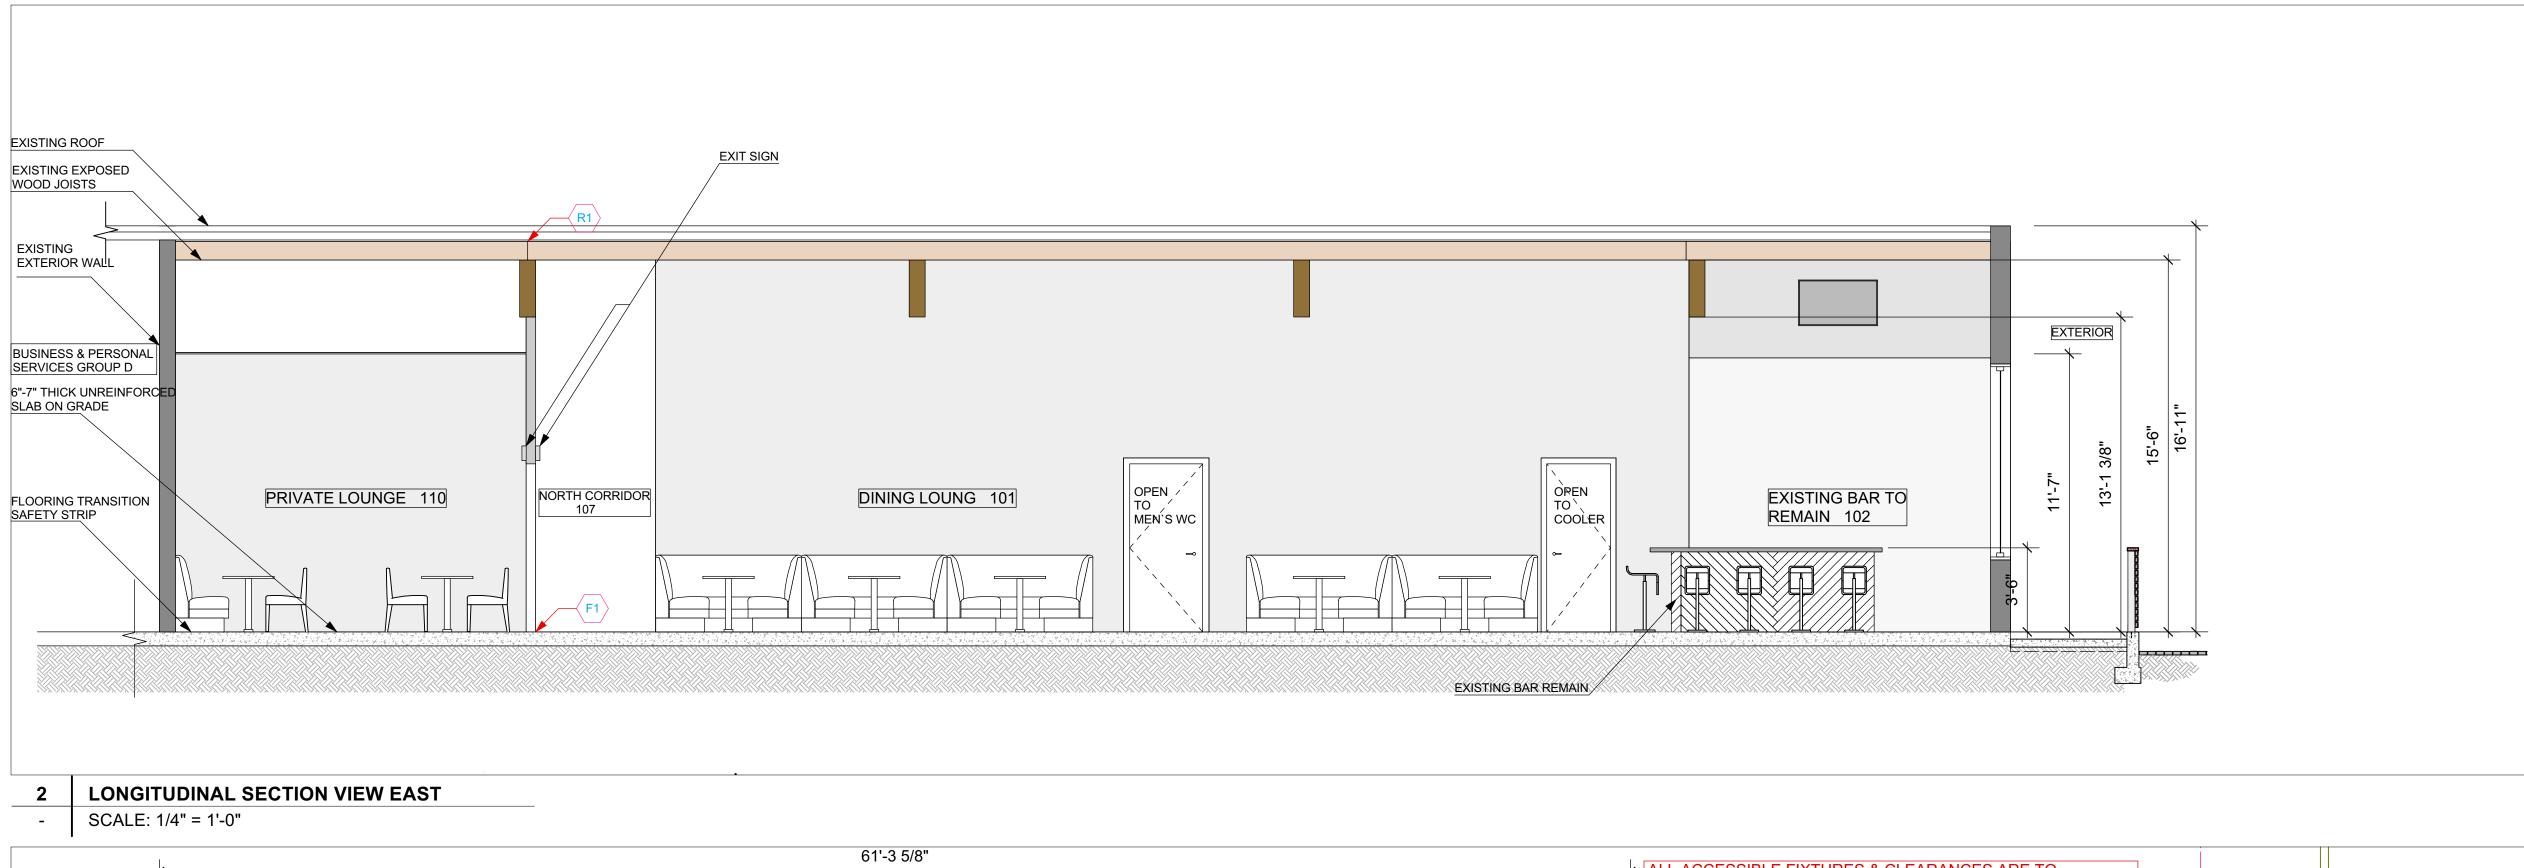

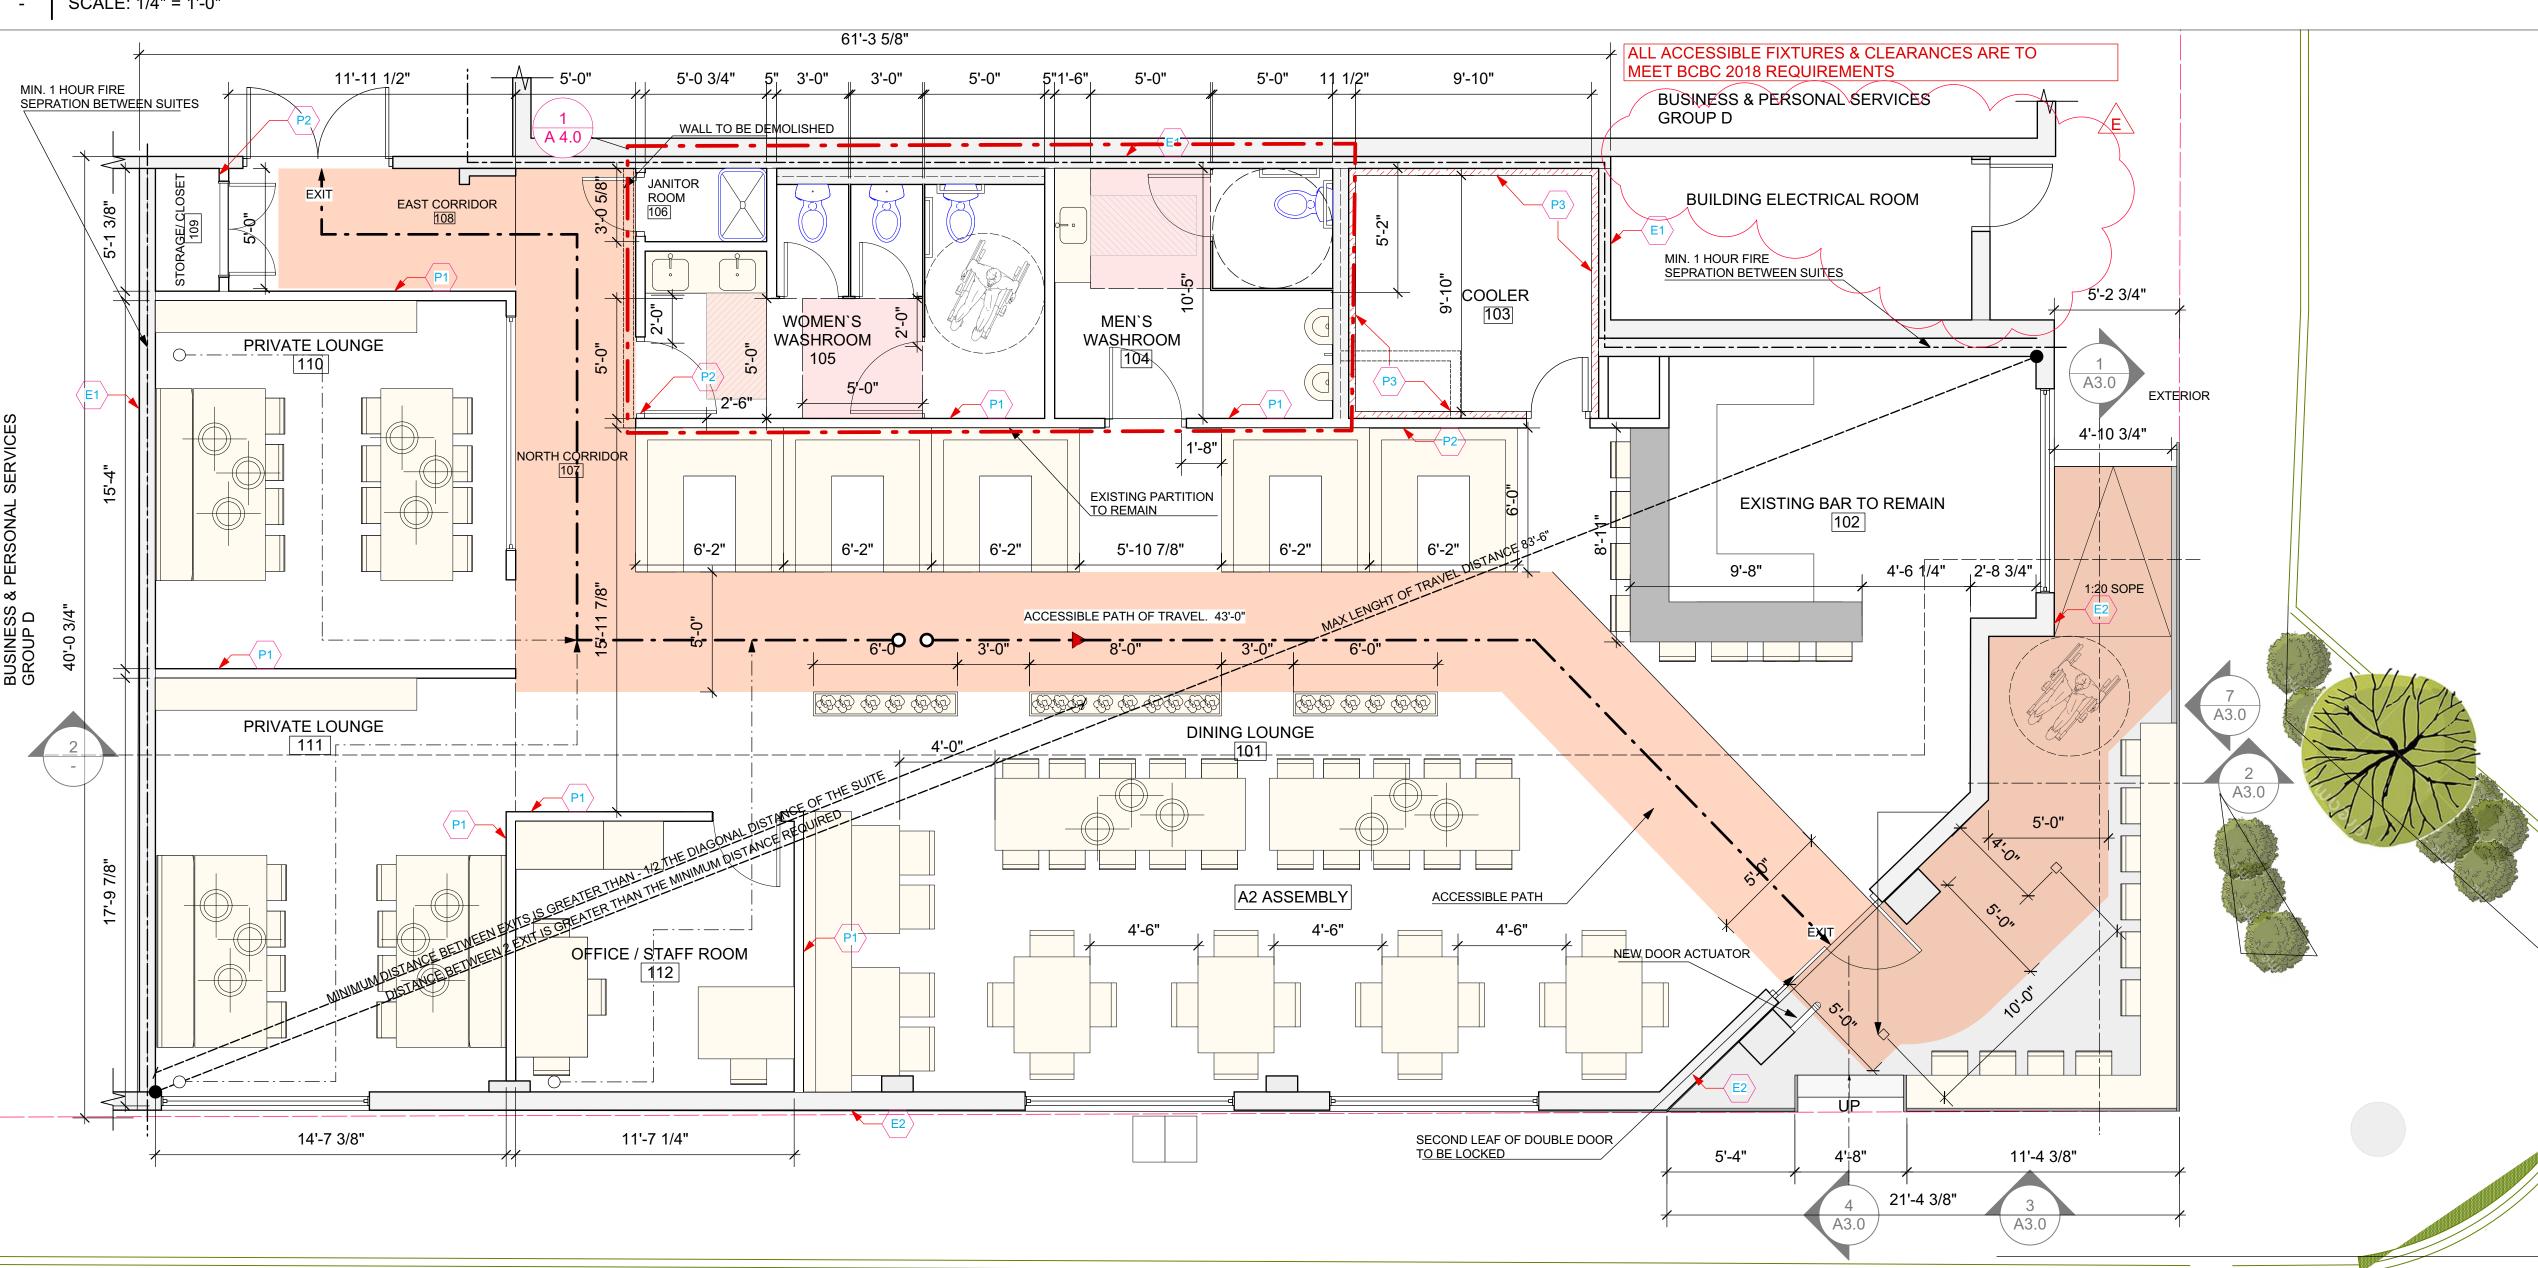

PROPOSED FLOOR PLAN

SCALE: 1/4" = 1'-0"

PARTITION SCHEDULE:

(NEW WALL)

EXISTING PARTITION - NON-RATED (NON-LOADBEARING) 1/2" GYPSUM WALL BOARD, 3-5/8" STEEL STUDS @ 24" O.C. INSULATED W/R12 ACOUSTIC INSULATED. 1/2" GYPSUM WALL BOARD

NEW PARTITION 1/2" GWB 3 5/8" STUDS @ 16" O/C INSULATED W/ ACOUSTIC BATT 1/2" GWB

COOLER INSULATED PARTITION - NON-RATED (NON-LOADBEARING) 5/8" GYPSUM WALL BOARD - PAINTED 3 5/8" STEEL STUDS COOLER INSULATED PANELS (BY MANUFACTURER)

> ADD 1H-SHAFT WALL ASSEMBLY W/ULC LISTING. TO BE INSTALLED ON SUITE SIDE OF EXISTING DEMISING WALL IF IT IS DETERMINED THAT THE DEMISING WALL DOSE NOT PROVIDE A 1 HOUR FIRE RESISTANCE RATING. ULDESIGN U415, SYSTEM A OR U469

EXISTING DEMISING WALL ASSEMBLY TO BE VARIFIED SHAFTWALL ASSEMBLY

INTERIOR OF WALL ASSEMBLY UNKNOWN CONTRACTOR TO VARIFY ASSEMBLY. SEE SW.1

(E2) EXIST. EXTERIOR WALL ASSEMBLY TO REMIN

(FLOOR/ROOF)

FLOOR FINISH (VARIES) OVER 6"-7" UNREINFORCED CONC. SLAB ON GRADE

ROOF MEMBRANE OVER INSULATION ON MILLDECK ON TIMBER JOISTS SUPPORTED BY GLULAM BEAMS

PROPOSED OCCUPANCY LOAD INTERIOR OCCUPANCY | 109 EXTERIOR OCCUPANCY STAFF OCCUPANCY TOTAL OCCUPANCY LOAD 123

COPYRIGHT:

NORTH:

All drawings, plans, specifications, reports, electronic data files, and working digital records (CAD Files), prepared by or on behalf of SURF Architecture, are Instruments of Service (IOS) and as such are the property of SURF Architecture. The exclusive copyright for SURF Architecture's IOS belongs to SURF Architecture. SURF Architecture's IOS are developed for the exclusive use of its Clients and their authorized Project Team participants. The IOS are to be used exclusively on the particular Project for which they were developed and are not to be used on any other project work without prior written authorization Due to the unsecured nature of electronic data transfer and the inability of

the originator to establish controls over the use thereof, SURF Architecture assumes no responsibility for any damages, errors or omissions, consequential or otherwise, arising from such use. Hard copy IOS take precedence over electronic data file IOS.

In the event that SURF Architecture's IOS are used for purposes other than interest and the surface of the surface intended, or if the IOS are amended, altered or revised in any manner whatsoever, without receiving SURF Architecture's prior written consent, anyone improperly using this information does so at their own risk.

Accessing the IOS provided, confirms acceptance of all conditions of use and the user agrees to indemnify, hold harmless and defend SURF Architecture from and against all claims, demands, losses, damages,

liability and costs (including costs between solicitor and user) arising from such use. COPYRIGHT © 2023 SURF Architecture

PROFESSIONAL SEAL:

FIRE & SMOKE SEPARATIONS

--- 1 1/2 HOUR

1 HOUR ———— 3/4 HOUR SMOKE SEPARATION (S.S.) (NO

── - - → EXIT PATH EXIT SIGN

2023-01-17 RESUBMITTED FOR BP 2023-01-12 SUBMITTED FOR BUILDING PERMIT 2023-01-06 ISSUE FOR CLIENT REVIW
2023-12-16 RESUBMITTED FOR B 2022-12-16 RESUBMITTED CO.
LIQUOR LICENSE APPLICATION

ARCHITECTURE

APPLICATION

DESCRIPTION

WHITE ROCK, BC V4B 3W7 TEL: 604.616.0646 email: mark@surfarchitecture.com www.surfarchitecture.com

2022-11-25

DATE

ISSUES

GALAXIE CRAFT BREWHOUSE

PROJECT: **GALAXI BREWING UPTOWN LOUNGE**


PROJECT ADDRESS: 15165 RUSSEL AVE WHITE ROCK B,C. V4B 2P4

DRAWING TITLE:

PROPOSED FLOOR PLAN

PROJECT NO: 2022 21 DRAWN BY: CHECKED BY DATE: 2022-12-16 SCALE: 1/4"=1'-0" REVISION NO: DRAWING NO:

A2.0

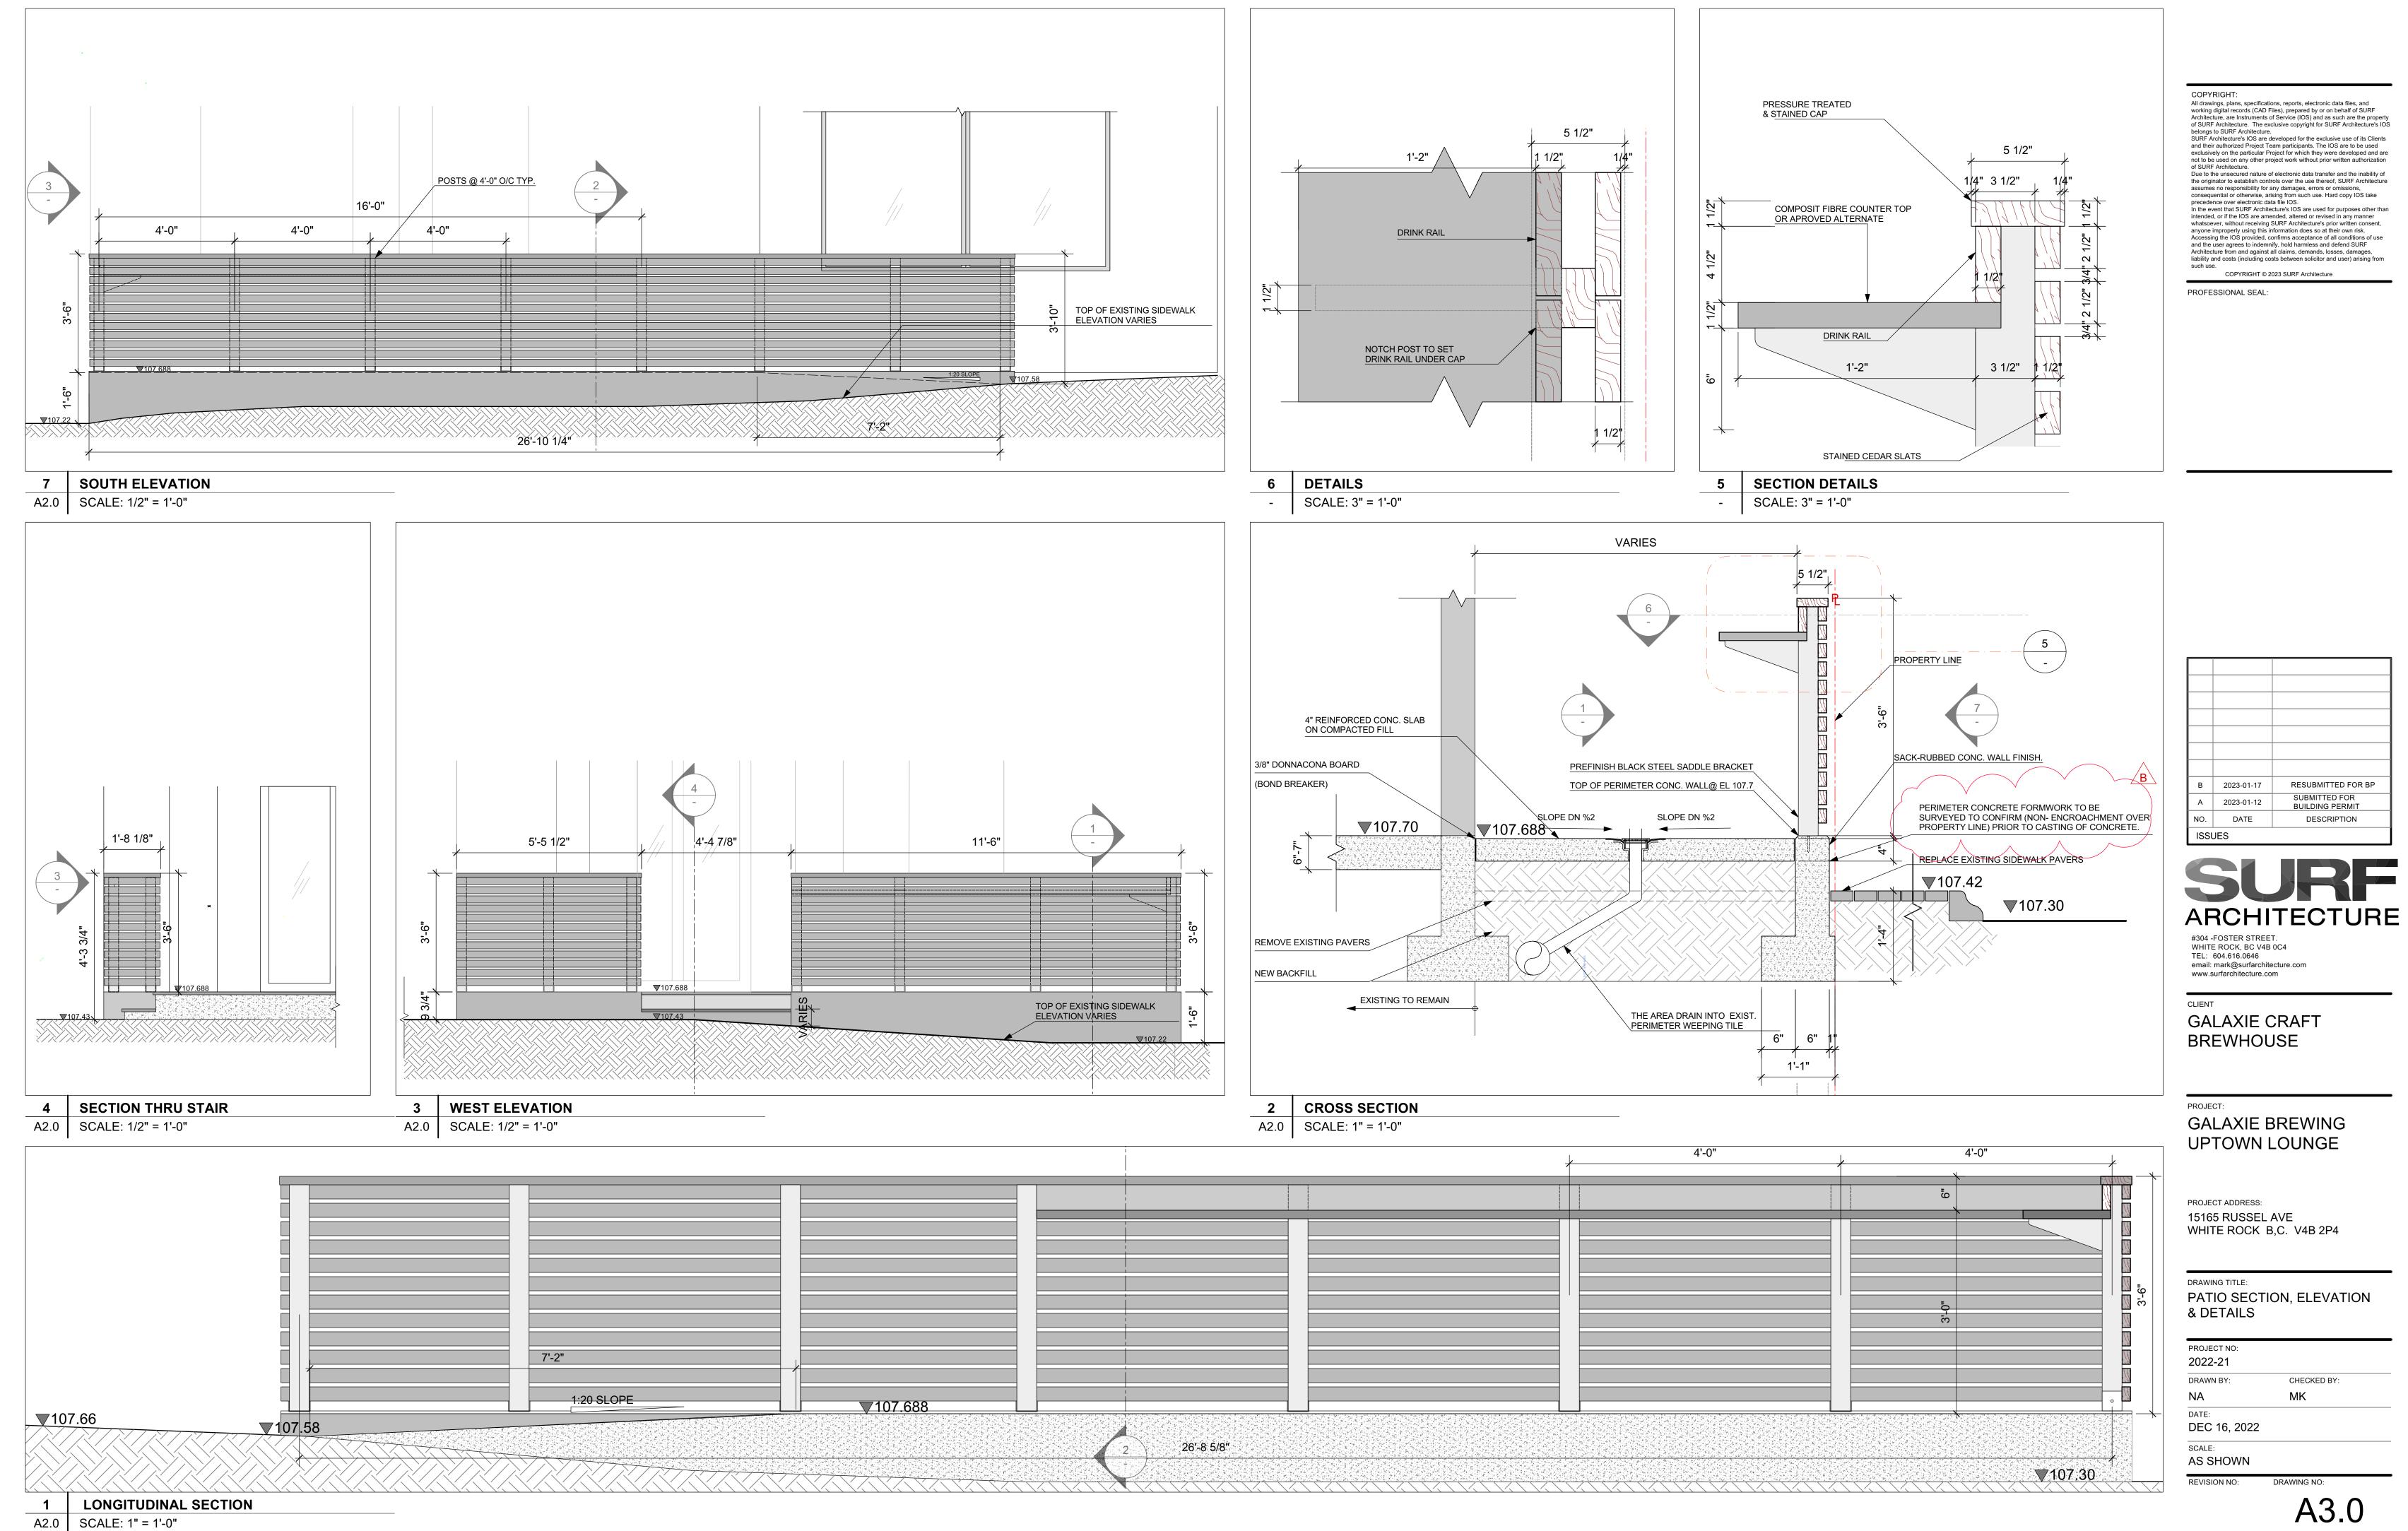

NORTH:

From: Doug Card
To: Neethu Syam

Subject: Hours and Entertainment

Date: Monday, March 20, 2023 2:04:47 PM

CAUTION: This email originated from outside of the organization. Do not click links or open attachments unless you recognize the sender and know the content is safe.

Hello Neethu, we agree to the hours proposed by City Staff shown in the table including patio hours suggested by staff in an earlier email. Regarding entertainment, we plan to have live musicians only.

We are requesting the City to help us endorse longer hours with LCRB simply to accommodate 3 events per year that may run past 11:00PM on Friday or Saturday. Thank you kindly.

Doug

Table: Proposed Hours of Public Operation										
Day	Monday	Tuesday	Wednesday	Thursday	Friday	Saturday	Sunday			
Open	12:00 PM	12:00 PM	12:00 PM	12:00 PM	10:00 AM	10:00 AM	10:00 AM			
Closed	10:00 PM	10:00 PM	11:00 PM	11:00 PM	11:00 PM	11:00 PM	9:00 PM			

Table: Proposed Hours of Patio Operation										
Day	Monday	Tuesday	Wednesday	Thursday	Friday	Saturday	Sunday			
Open	12:00 PM	12:00 PM	12:00 PM	12:00 PM	10:00 AM	10:00 AM	10:00 AM			
Closed	9:00 PM	9:00 PM	9:00 PM	9:00 PM	9:00 PM	9:00 PM	7:00 PM			