

ATTACHMENT C

15409 Buena Vista Avenue


(City File: 22-012)

- Location Map and Ortho Map (illustrating the location and context of the property)
- Legal Survey
- Architectural Drawings and Renderings
- Arborist Report

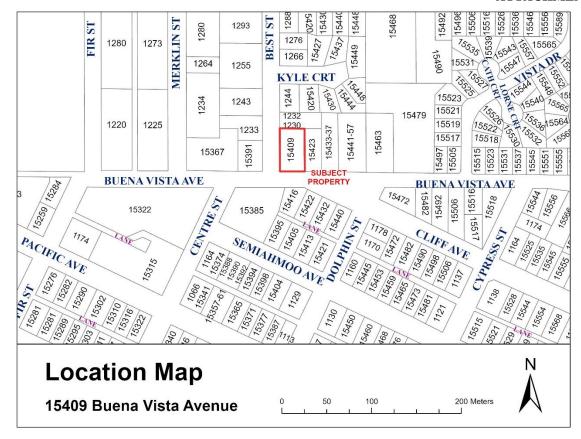

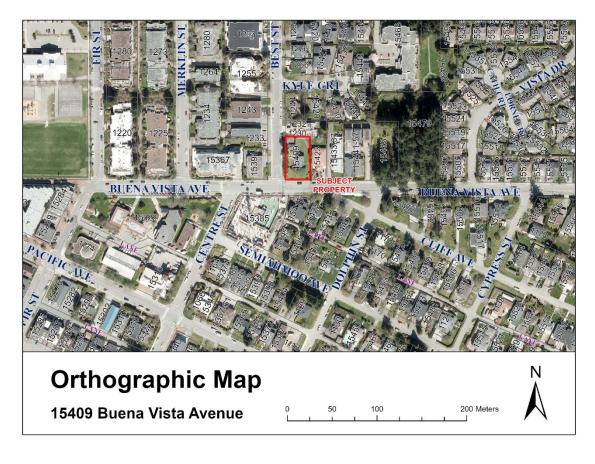

TOPOGRAPHIC SITE PLAN OF LOT 1 SECTION 11 TOWNSHIP 1 NEW WESTMINSTER DISTRICT PLAN 14462

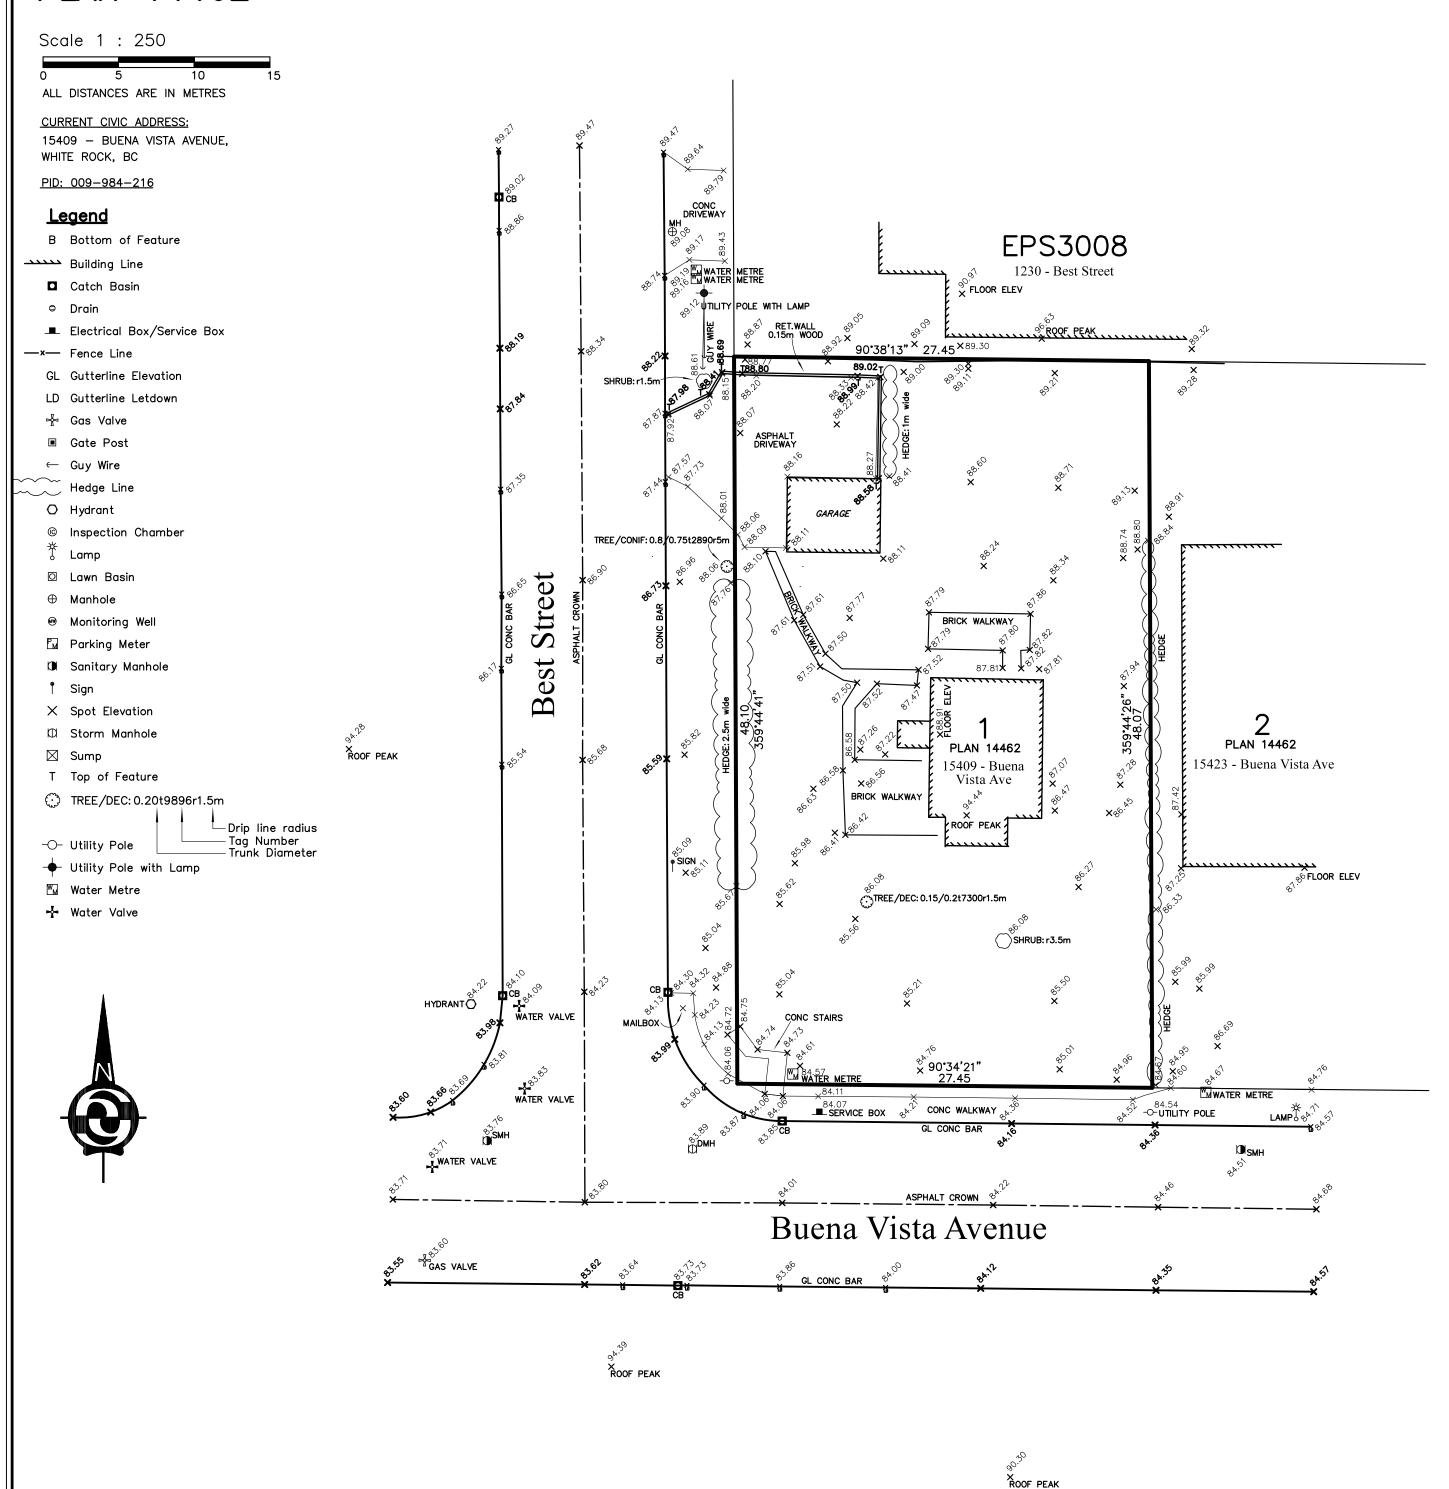

PROPERTY BOUNDARIES	DRAWING NOTES	ELEVATION DERIVATION		
 LEGAL BOUNDARIES ARE DERIVED FROM LAND TITLE OFFICE RECORDS ONLY. PROPERTY BOUNDARIES BASED ON POSTING PLAN EPP39430. THIS PLAN IS NOT TO BE USED FOR DETERMINATION OF PROPERTY BOUNDARIES. CHARGES WITHOUT ACCOMPANYING PLANS HAVE NOT BEEN SHOWN. REFER TO CURRENT CERTIFICATE OF TITLE FOR ADDITIONAL CHARGES. 	 TREE DIMENSIONS AND SPECIES SHOULD BE CONFIRMED BY A CERTIFIED ARBORIST. TRUNK DIAMETER MEASURED 1.4m ABOVE GRADE. FEATURES SHOWN ARE VISIBLE AT GROUND LEVEL. NO SURVEY OR RESEARCH HAS BEEN CONDUCTED FOR BURIED SERVICES. BUILDING LOCATIONS ARE SHOWN TO THE EXTERIOR FACE OF THE EXTERIOR WALL. 	ELEVATIONS DERIVED FROM CITY OF WHITE ROCK MONUMENT 88H3880 LOCATED AT THE INTERSECTION OF BEST STREET AND BUENA VISTA AVENUE ELEV= 83.781m CVD28GVRD2018	DATE OF FIELD SURVEY DECEMEBR 20, 2021 EUGENE WONG B.C.L.S.	H.Y. Associates Land Surveying Ltd. British Columbia Land Surveyors #200, 9128 - 152nd Street Surrey, B.C. V3R 4E7 Tel. 604-583-1616 File: 215835LS Dwg: 215835_TO.DWG

ATTACHMENT C

OCP Amendment 15409 Buena Vista Avenue White Rock

Proposed 15-unit Apartment Building

Lot 1 Section 11 Township 1 New Westminster District Plan 14462





Architect AIBC MRA

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1	Issued for Preliminary Review	2021-11-2
2	Issued for OCP Amendment	2022-02-2
3	Revised for OCP Amendment	2022-12-1

OCP Amendment


15409 Buena Vista Avenue White Rock, B.C.


Cover Sheet

Project number	2107
Date	2021-11-26
Drawn by	JYT
Checked by	RAS

A100

ale: 1:200

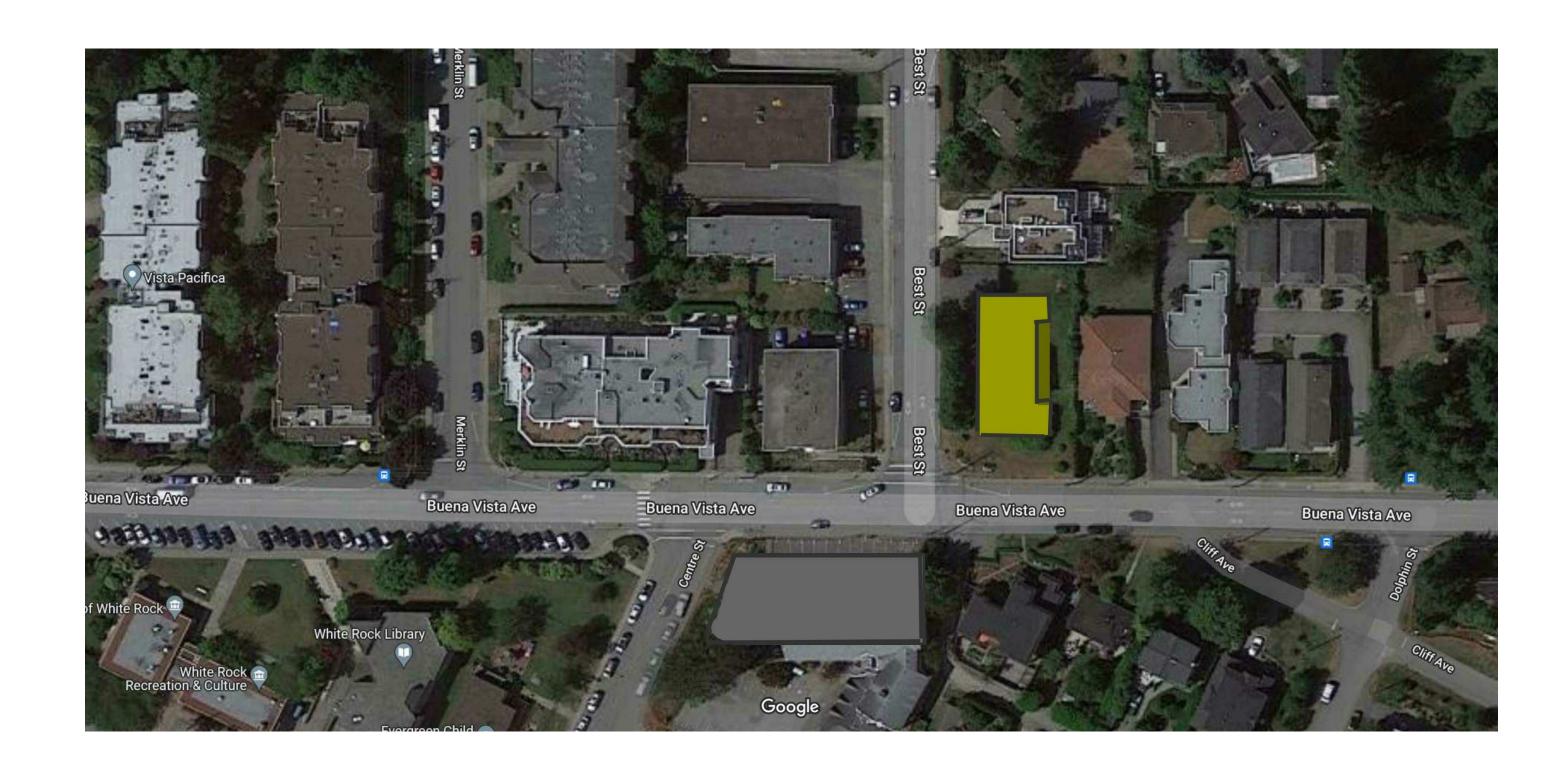

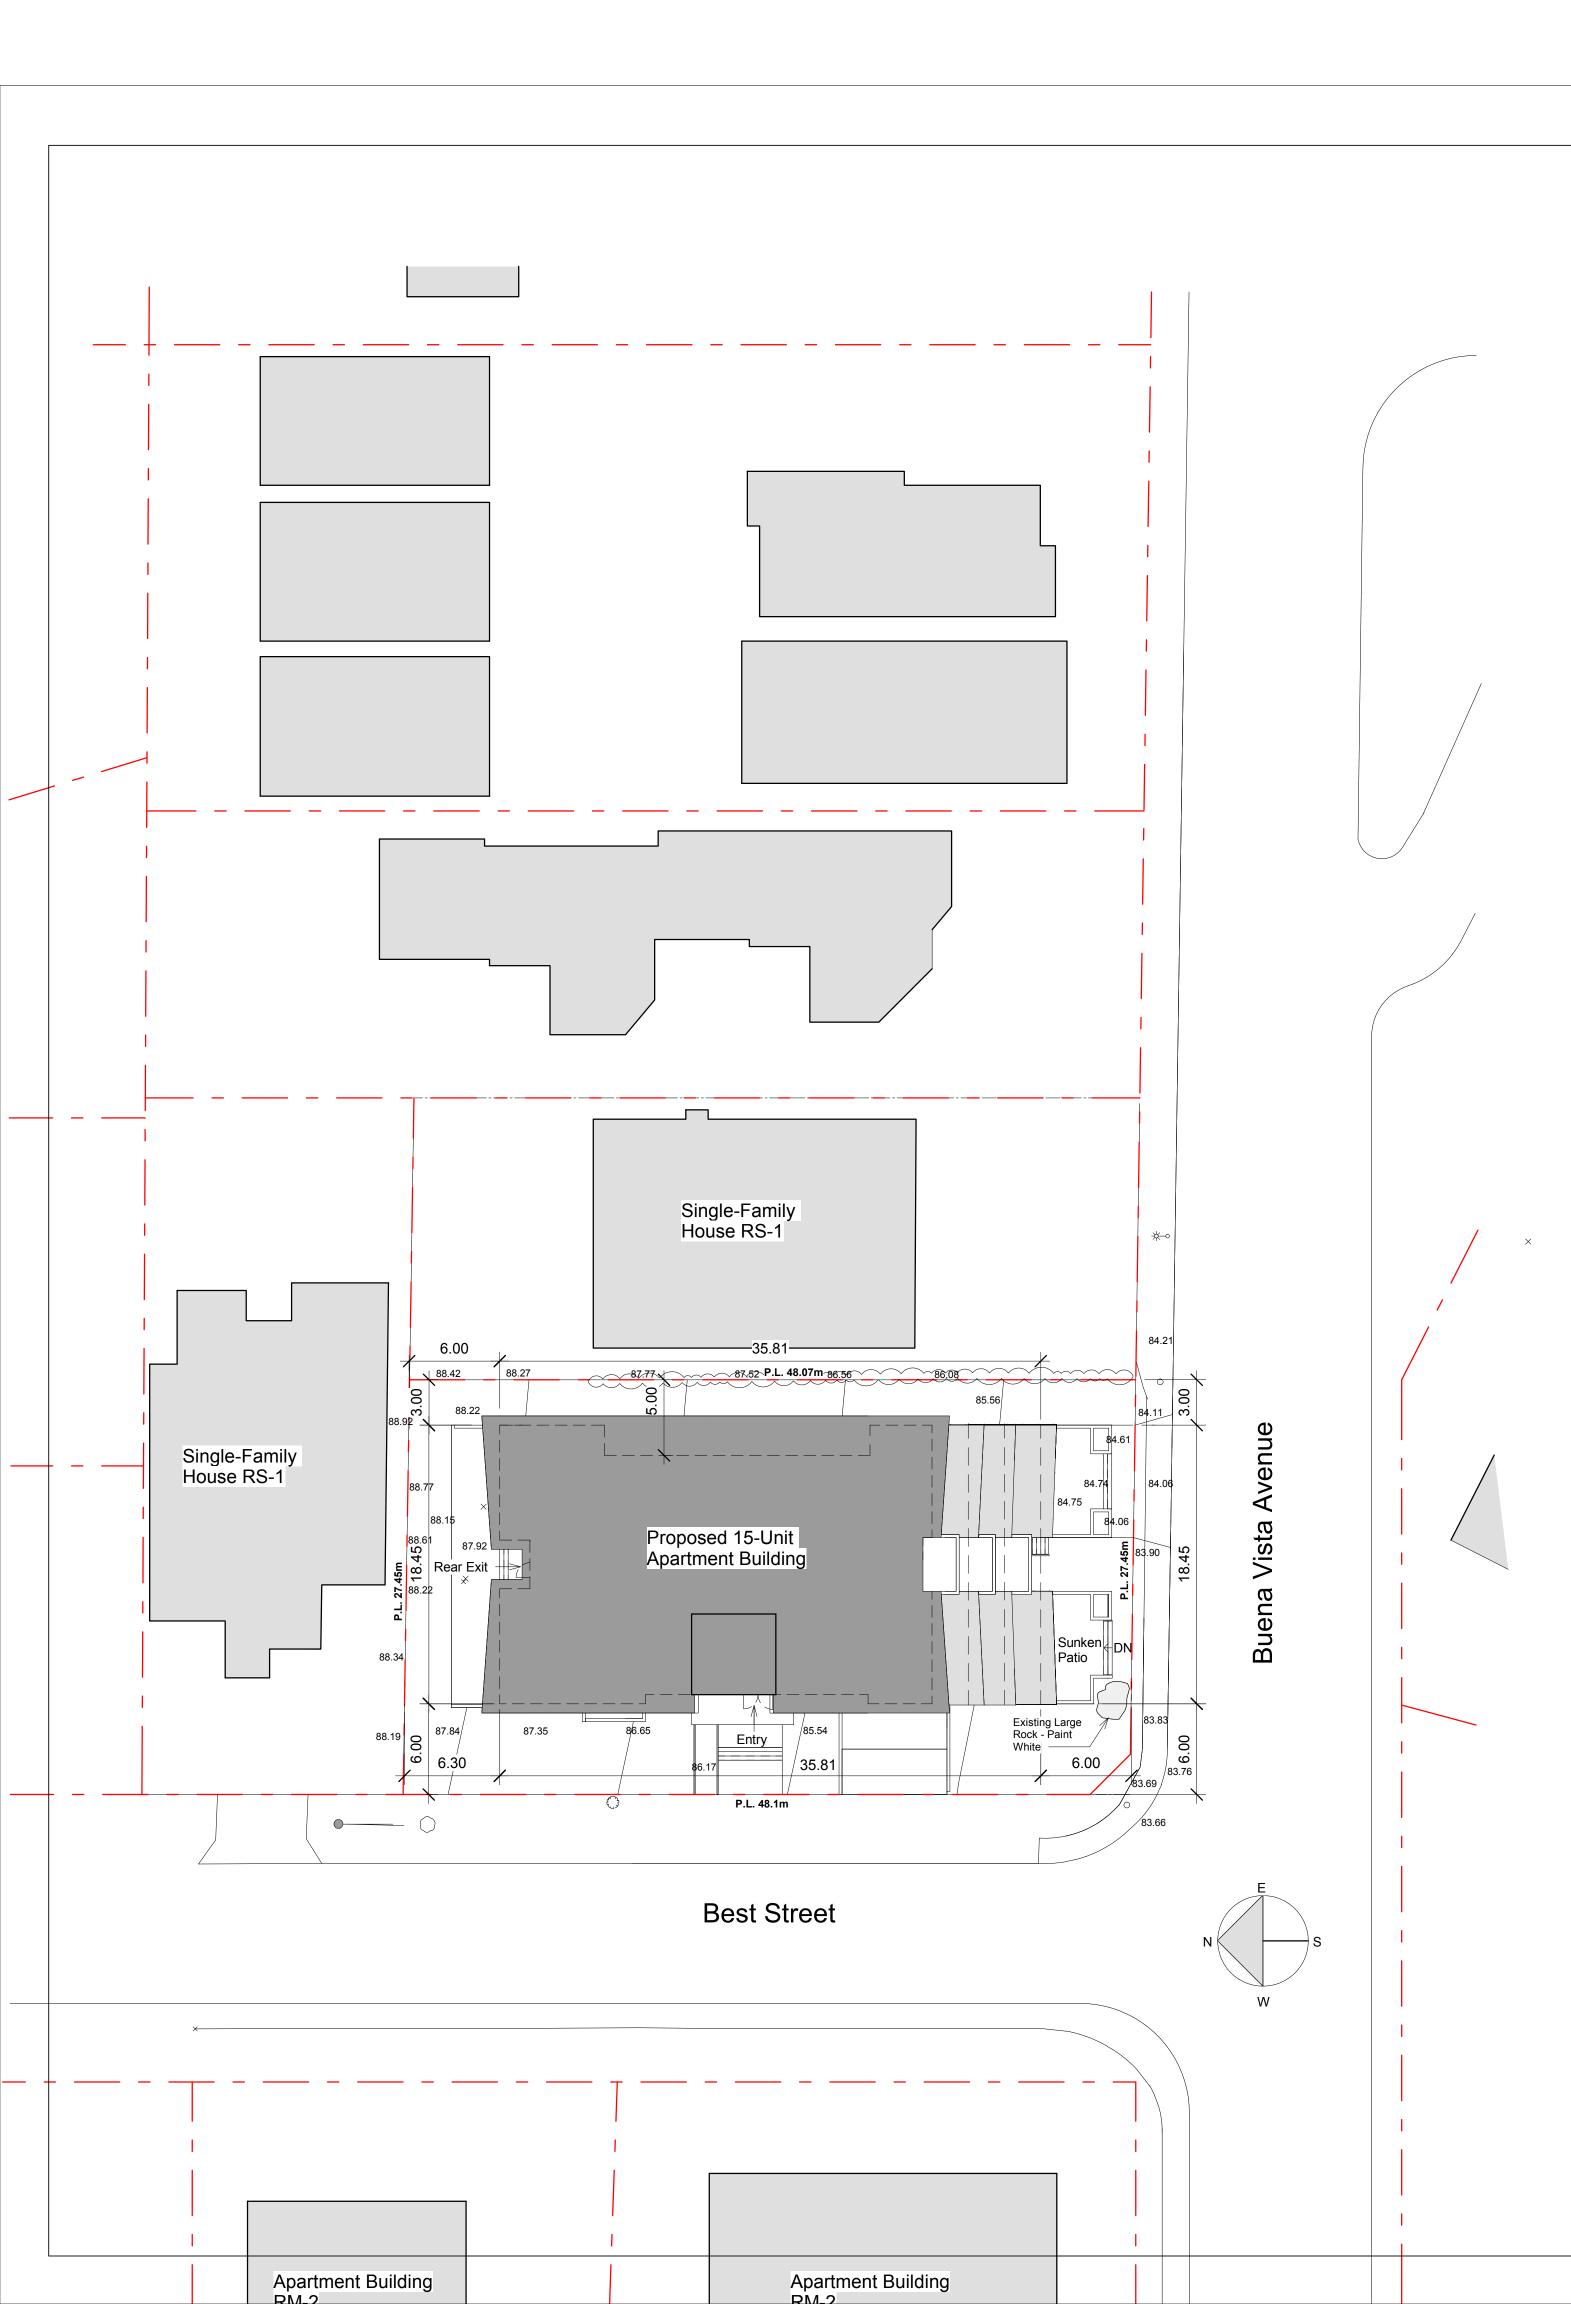



OCP Amendment & Rezoning - From RS-1 to RM-2:

Requirement	equirement RS-1 Allowable/ Requited		Provided	
Lot Size	15.0m x 27.4m 464 sq.m.	18.0m x 30.5m 742 sq.m.	27.45m x 48.1m 1,315 sq.m.	
Setbacks Front Rear Exterior side Interior side - with windows	7.5m 7.5m 7.5m 1.5m	6.0m 6.0m 6.0m 3.0m 5.0m	6.0m 6.3m 6.0m 3.0m 5.0m	
Building Height	7.7m	10.7m	10.7m (3 stories + basement)	
South Facade Height	(upper floor max. 80% of main floor)	6.0m (from avg. grade)	6.0m (from avg. grade)	
Site Coverage	40% 526 sq.m.	45% 592 sq.m.	45.7% 601.7 sq.m.	
Residential FAR	0.50 657.5 sq.m.	1.10 1,446 sq.m.	1.01 1,331 sq.m.	
Parking	2 spaces	23 spaces	17 underground (3 small car; 1 accessible; 1 EV level 2)	
Bicycle Parking		18 spaces	12 spaces	
Density	1 unit	50 units / 0.4ha = 16 units	15 units	



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1 Issued for Preliminary Review 2021-11-26 Issued for OCP Amendment
Revised for OCP Amendment 2022-02-28 2022-12-16

OCP Amendment


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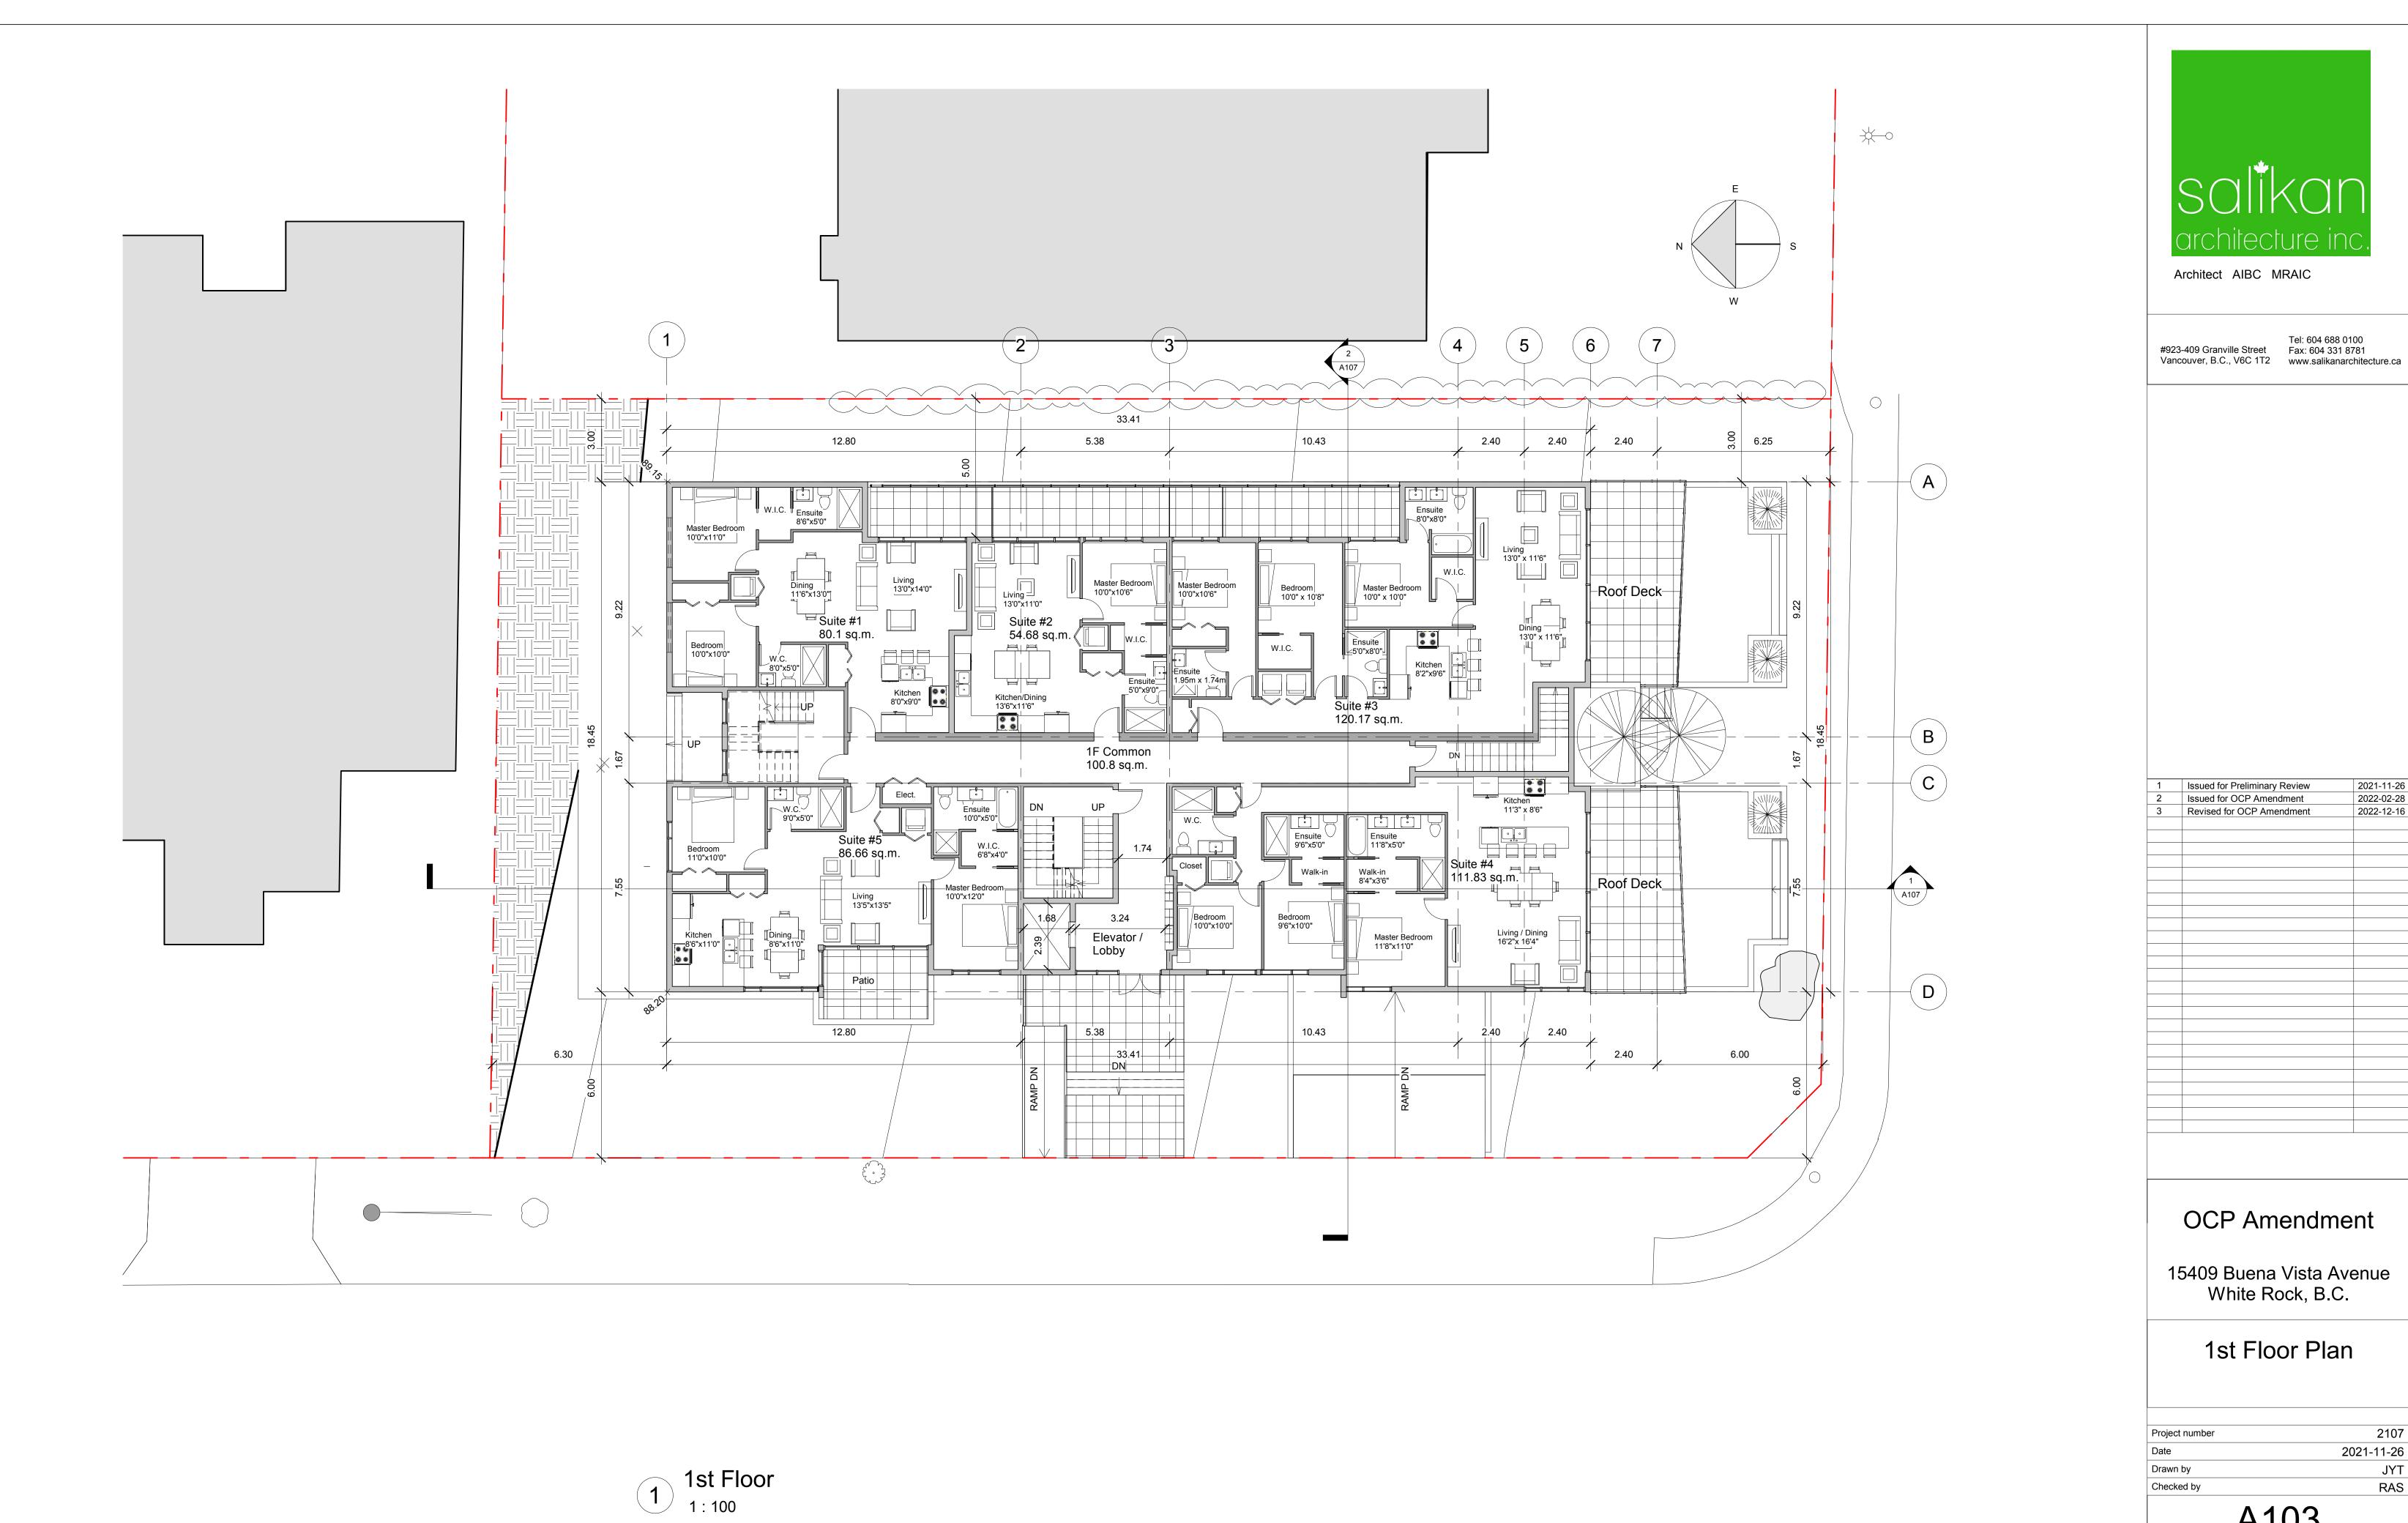
Site Plan, Project Data, 3D View

2107 Project number 2021-11-26 Drawn by RAS Checked by

A101

Scale: 1:200



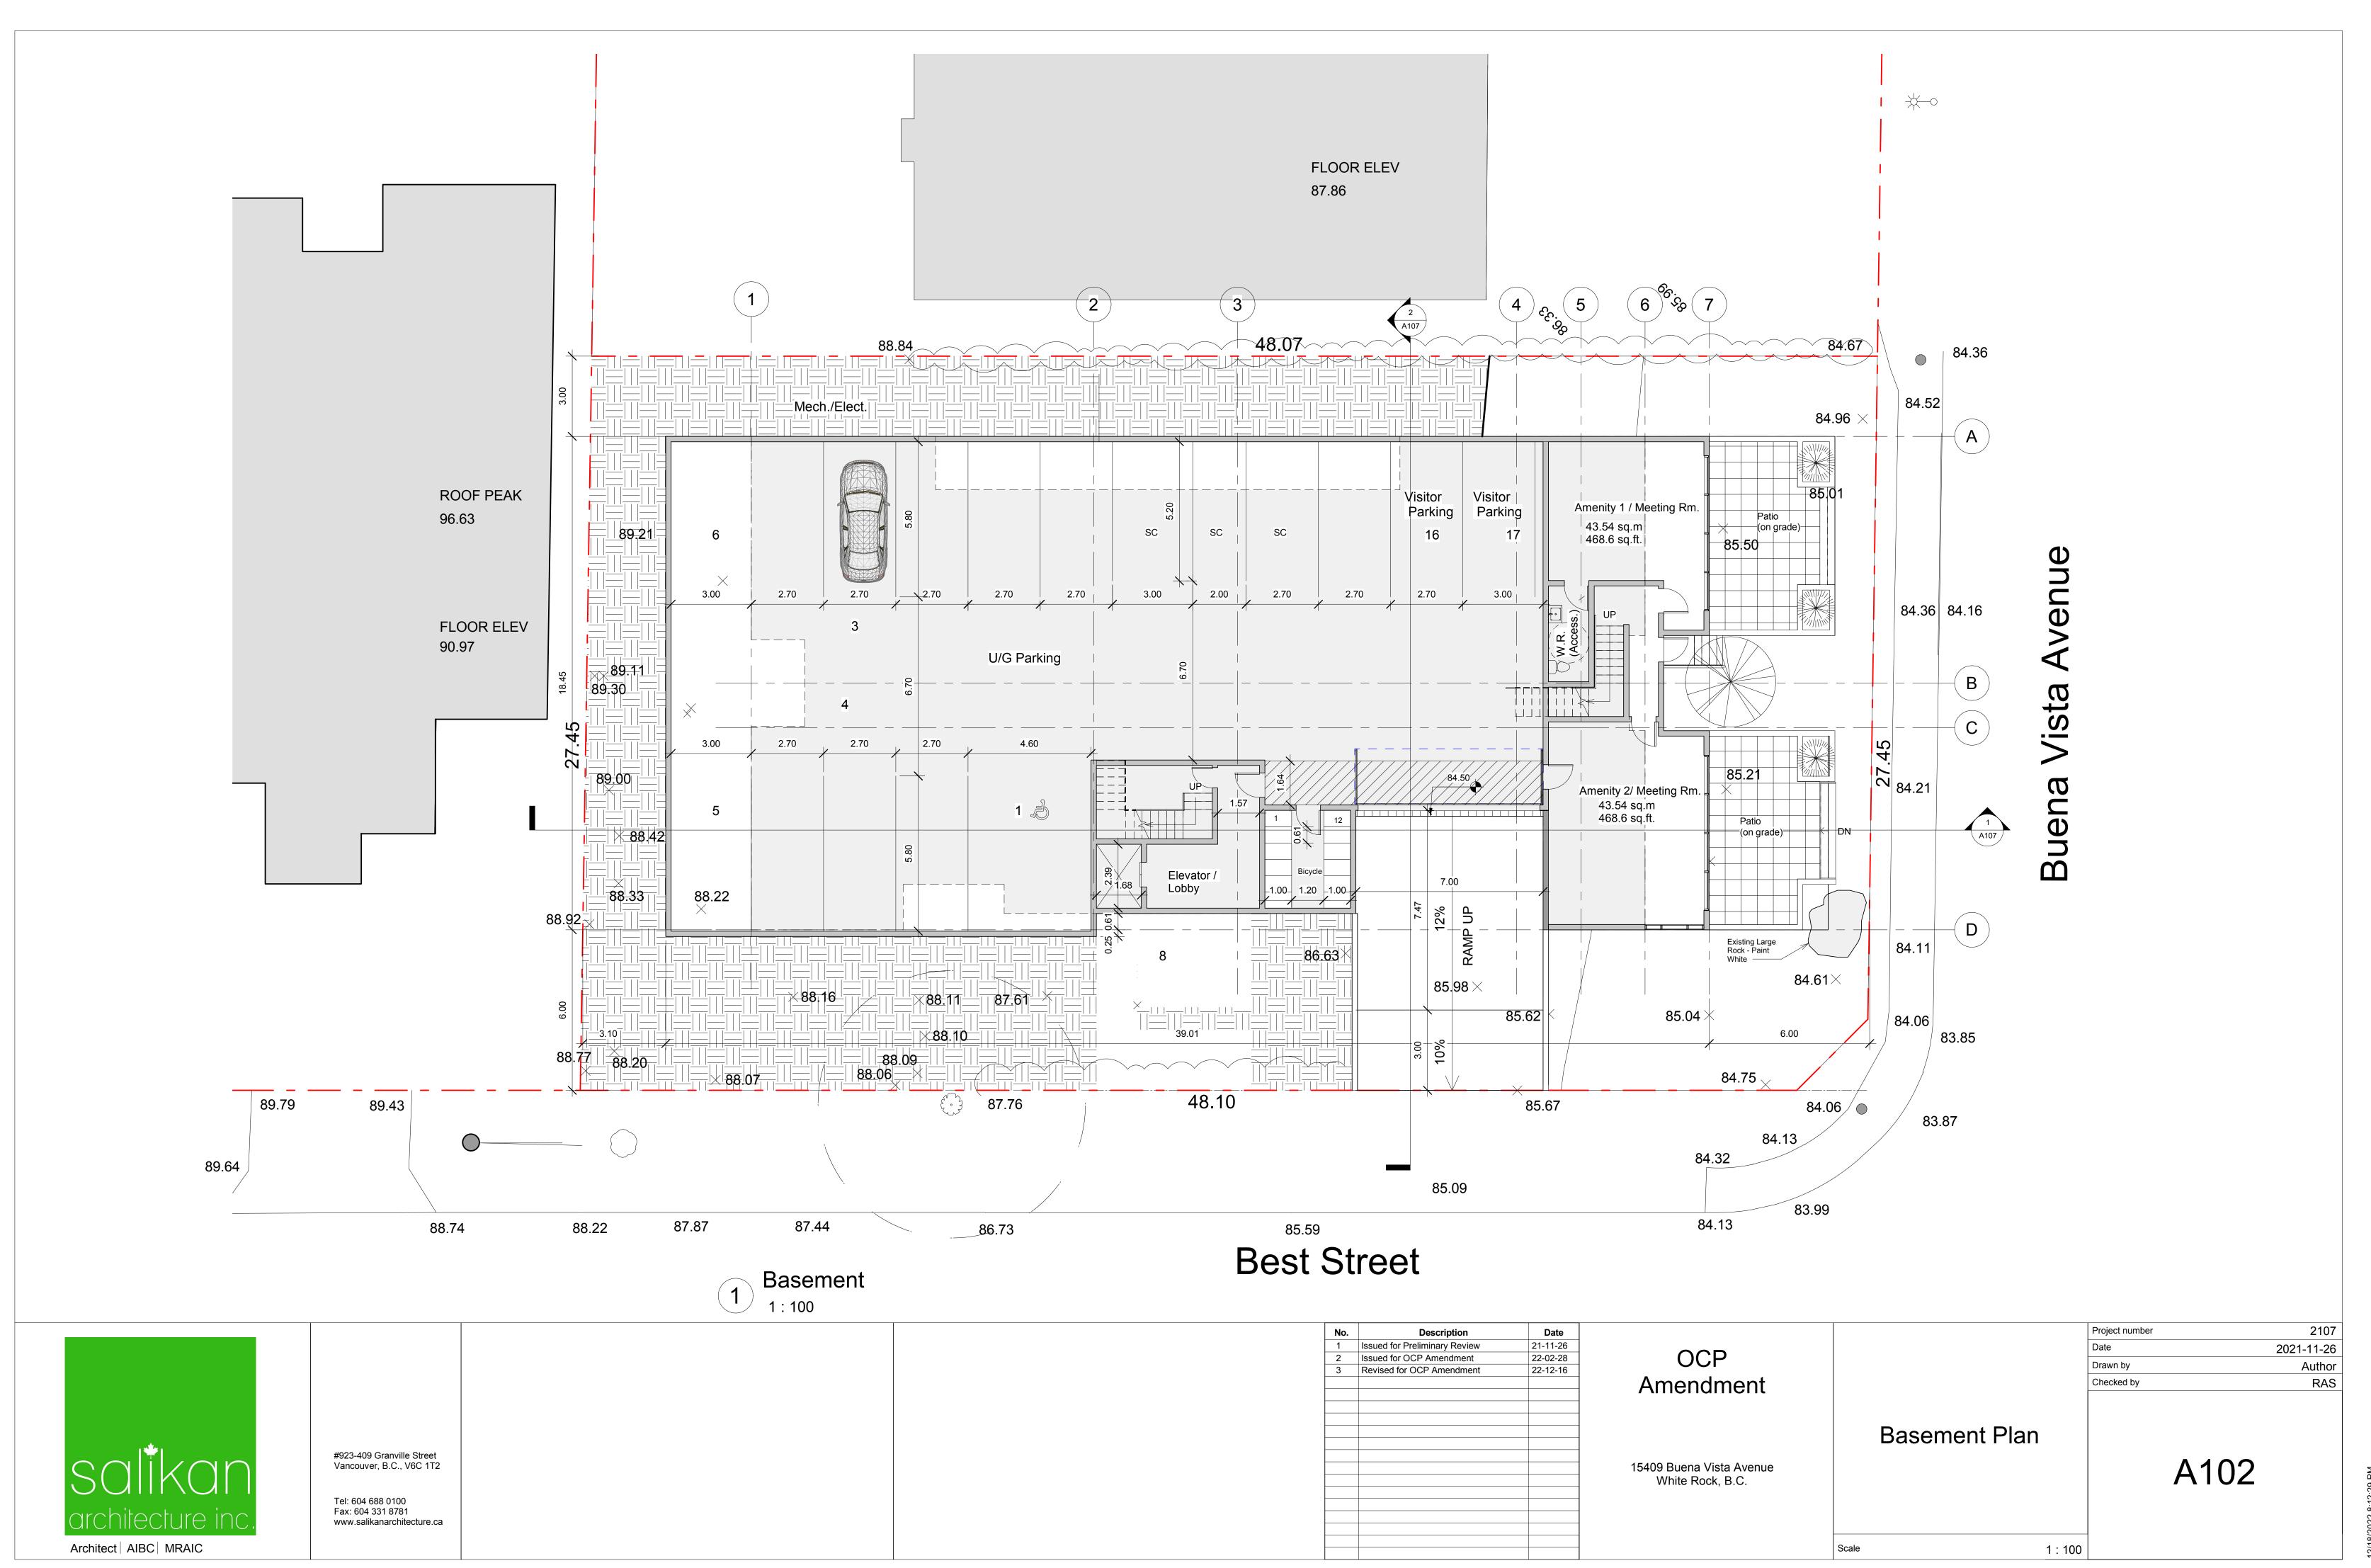


2021-11-26 2022-02-28 2022-12-16


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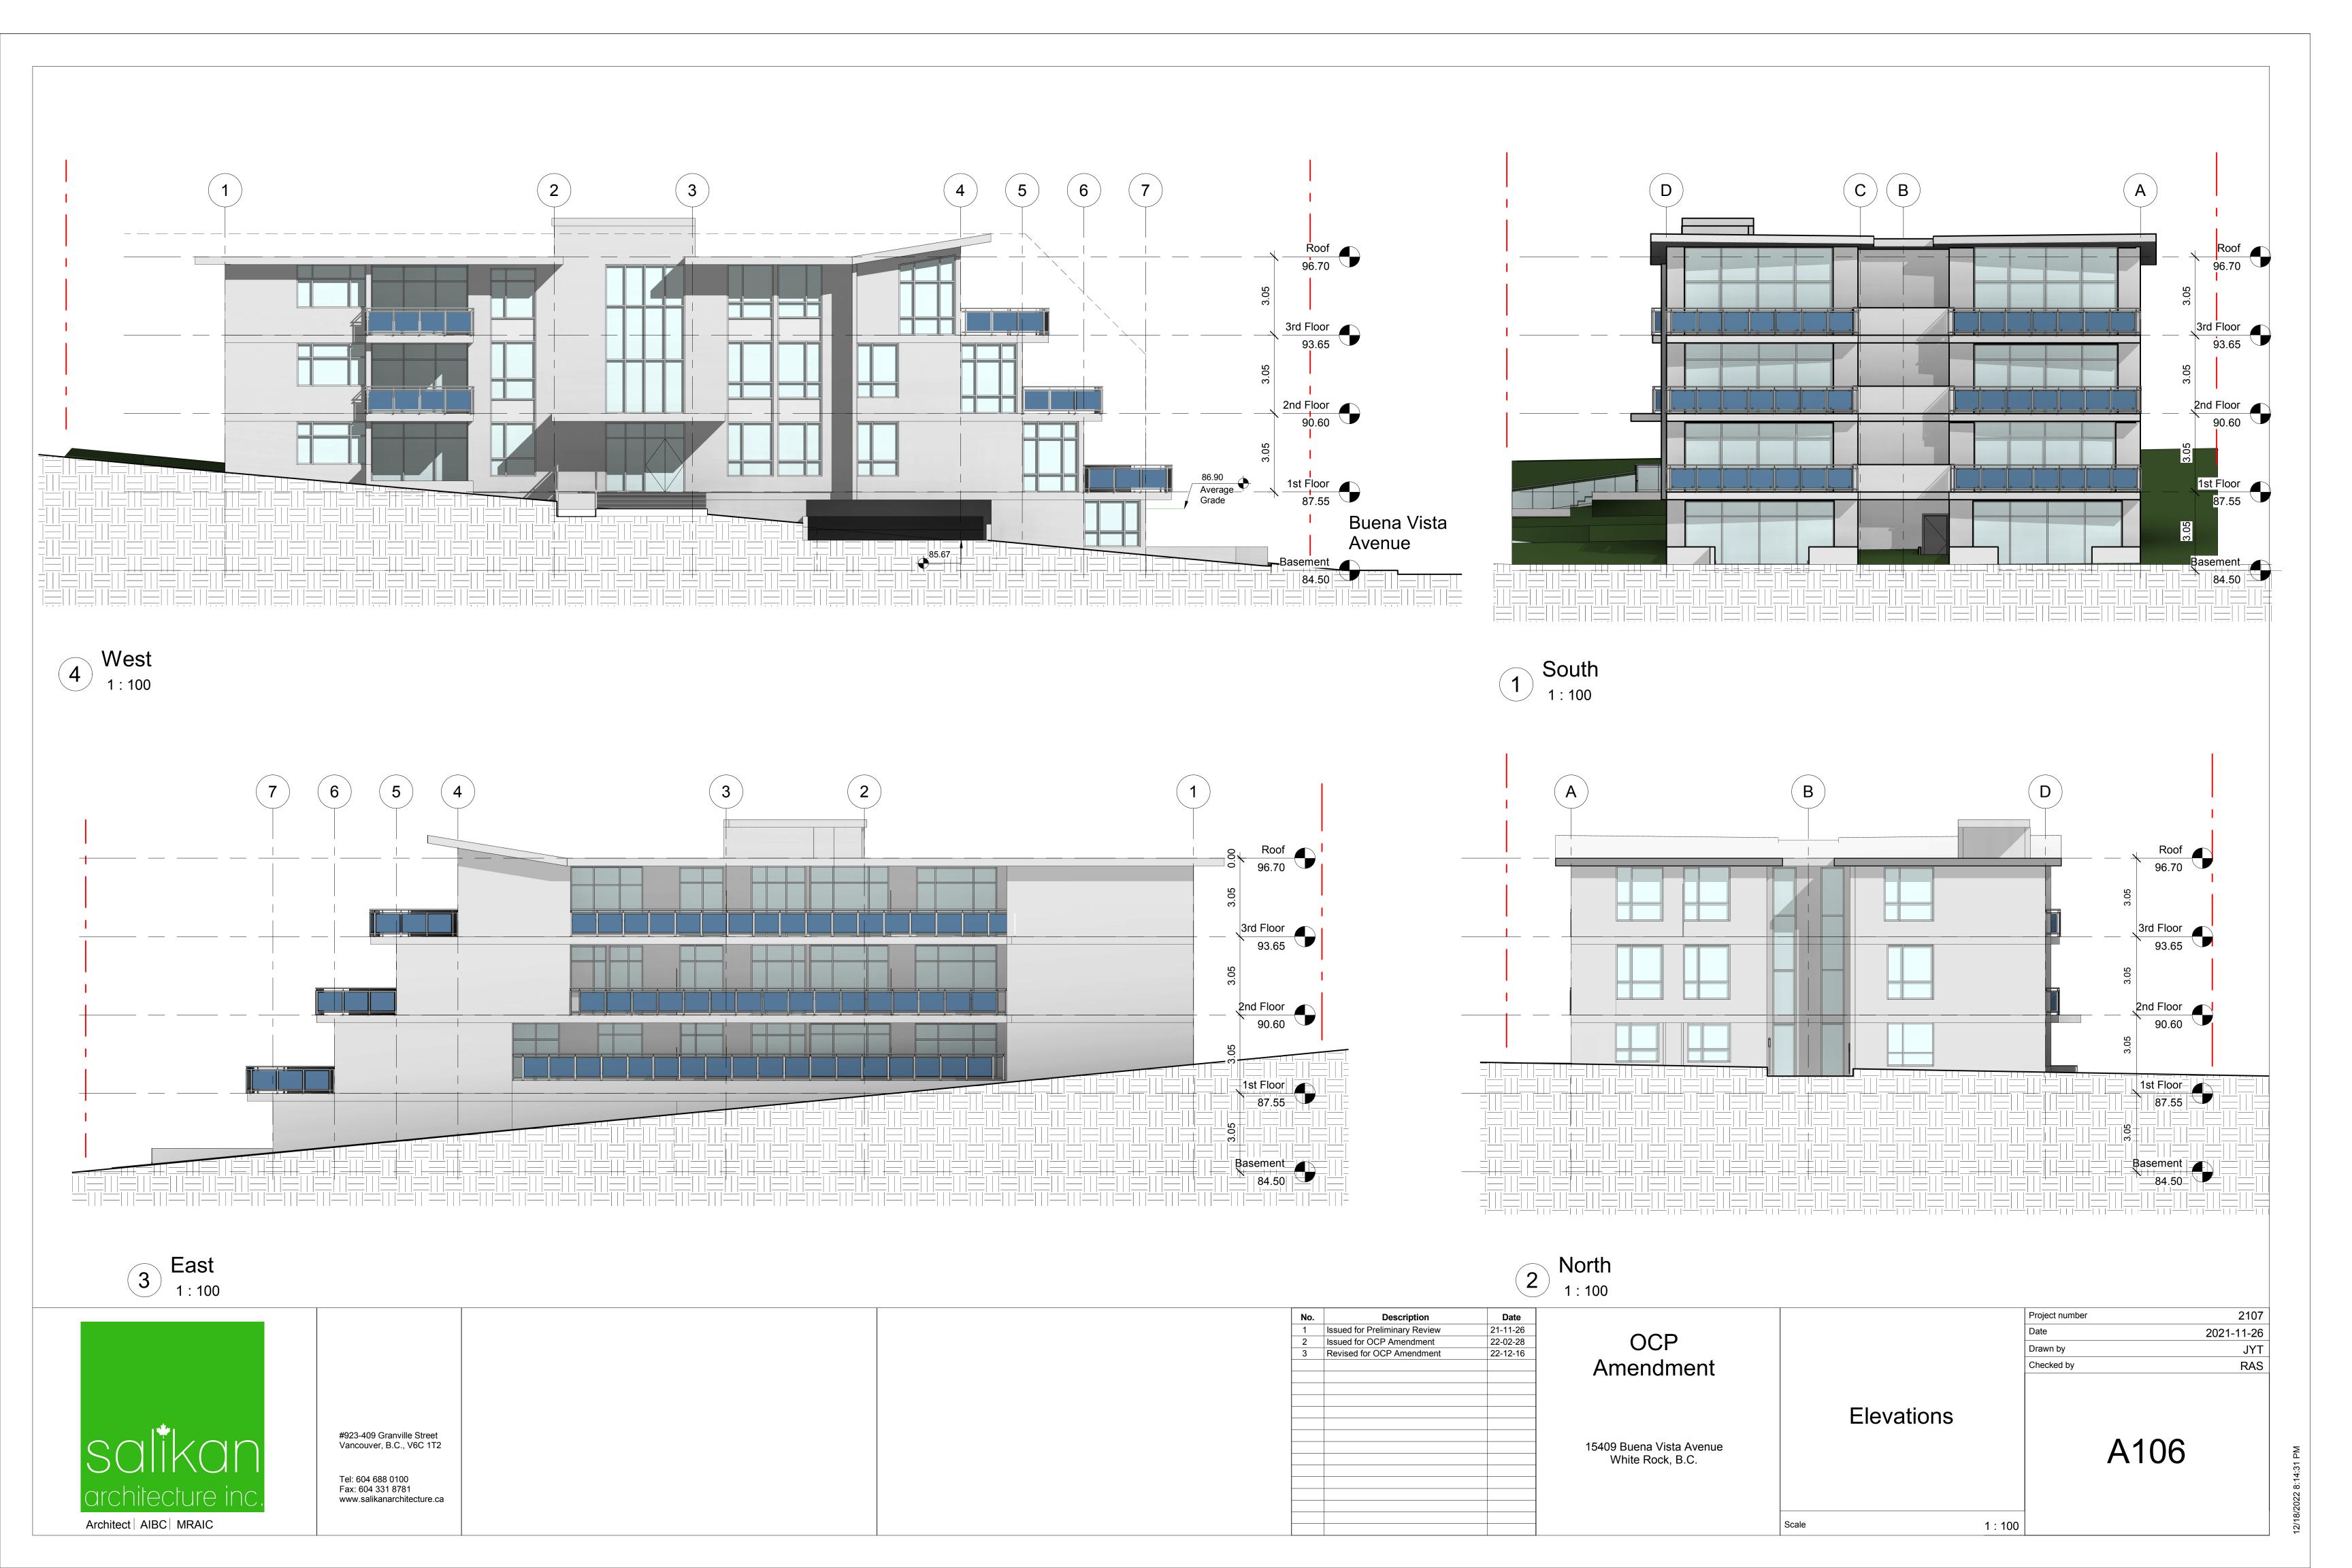
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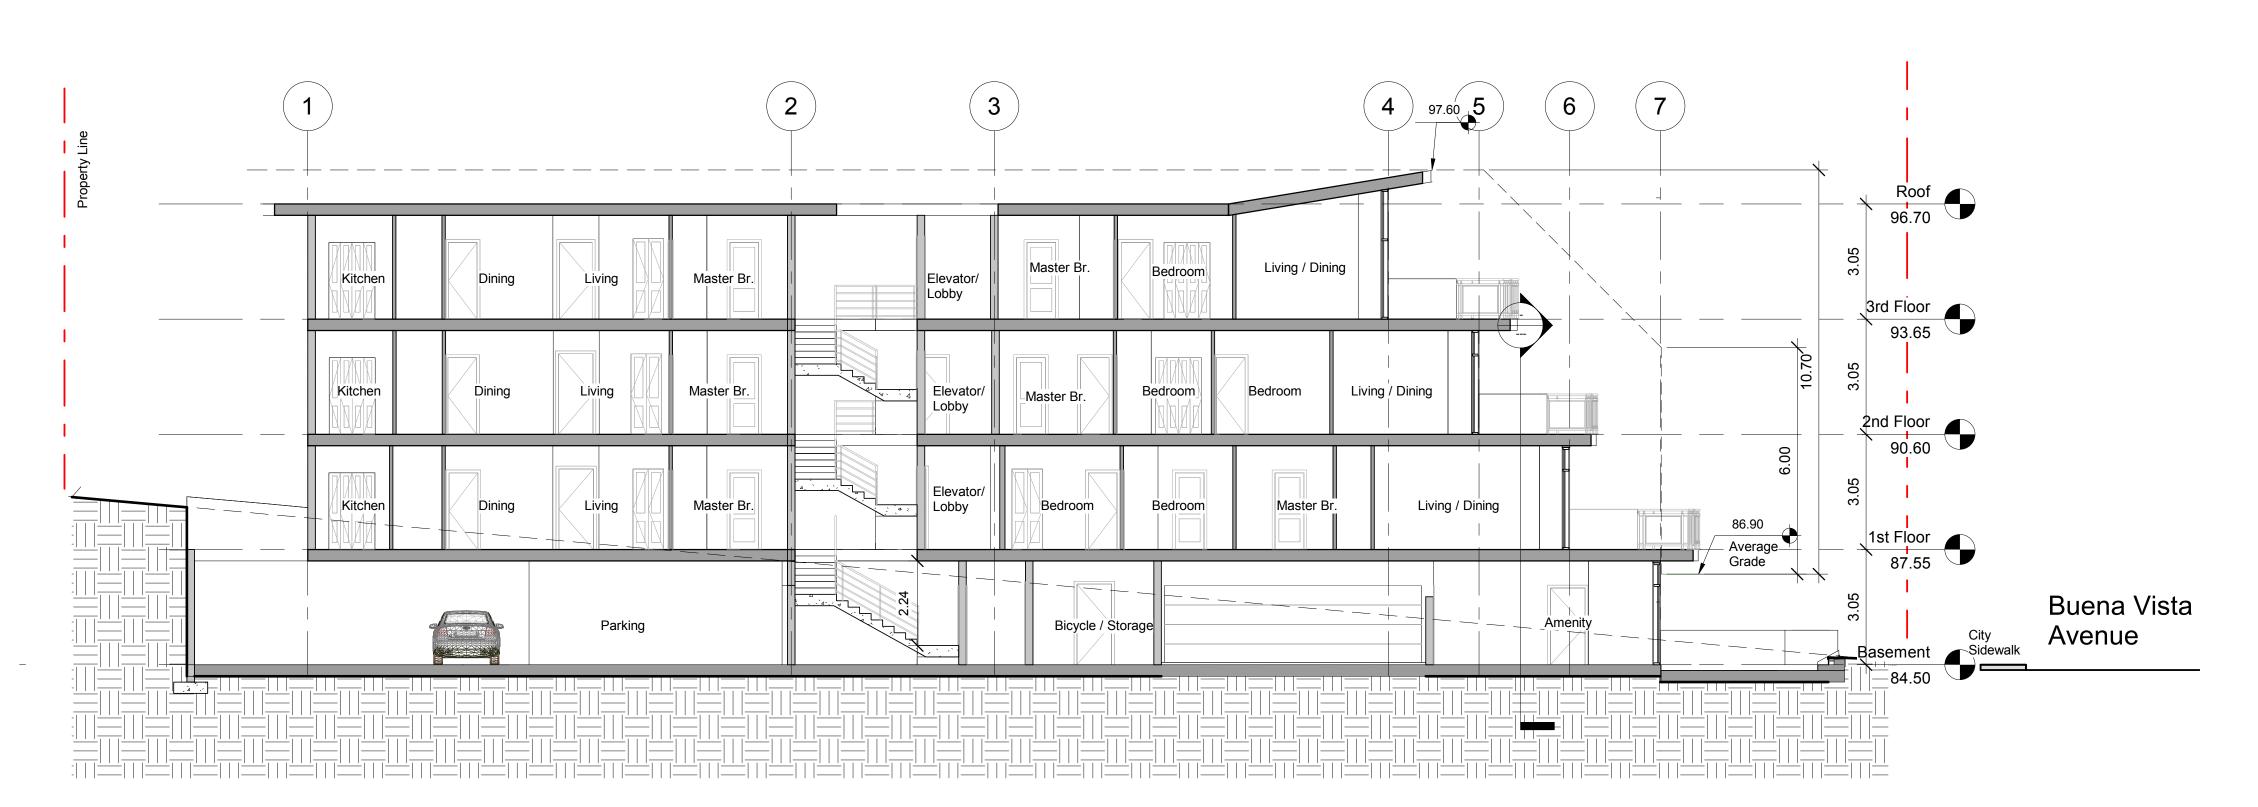
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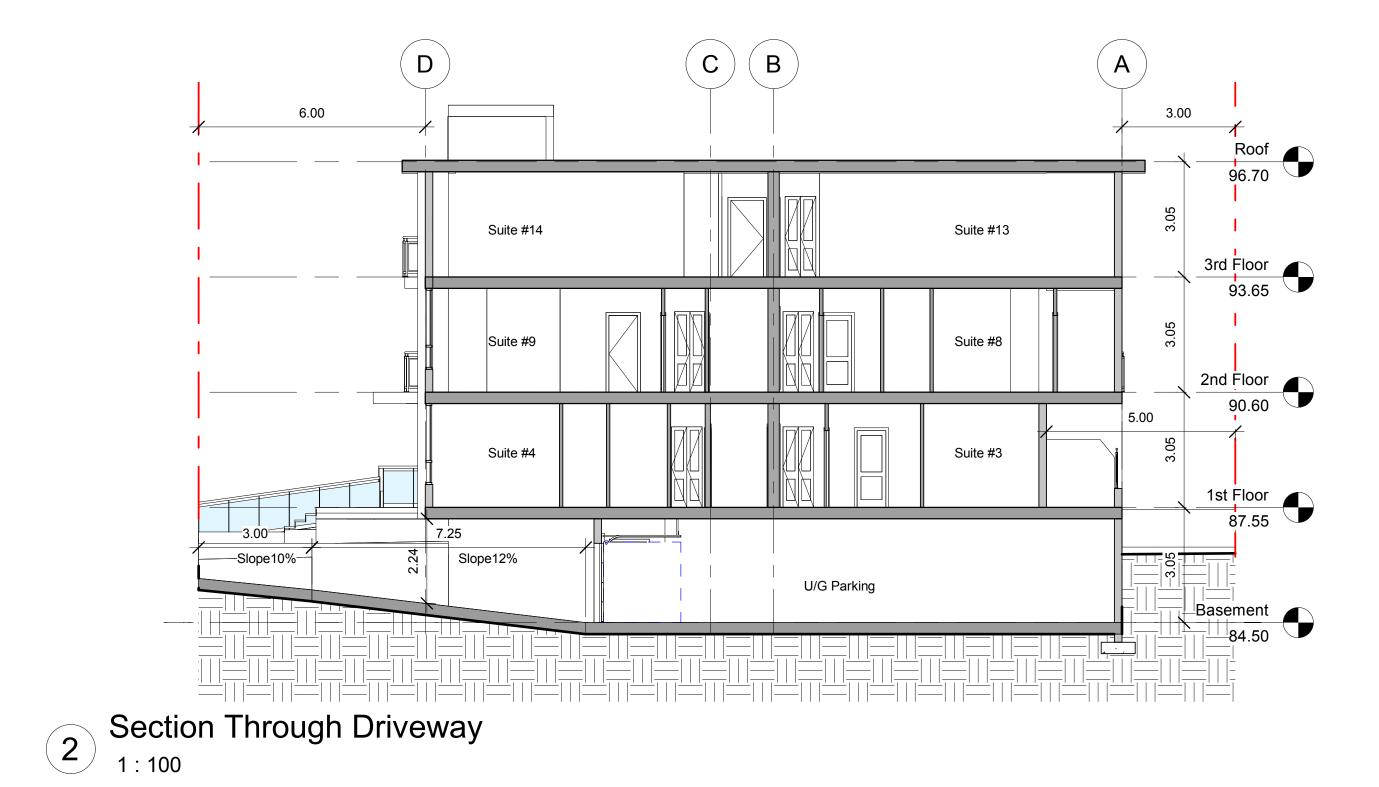




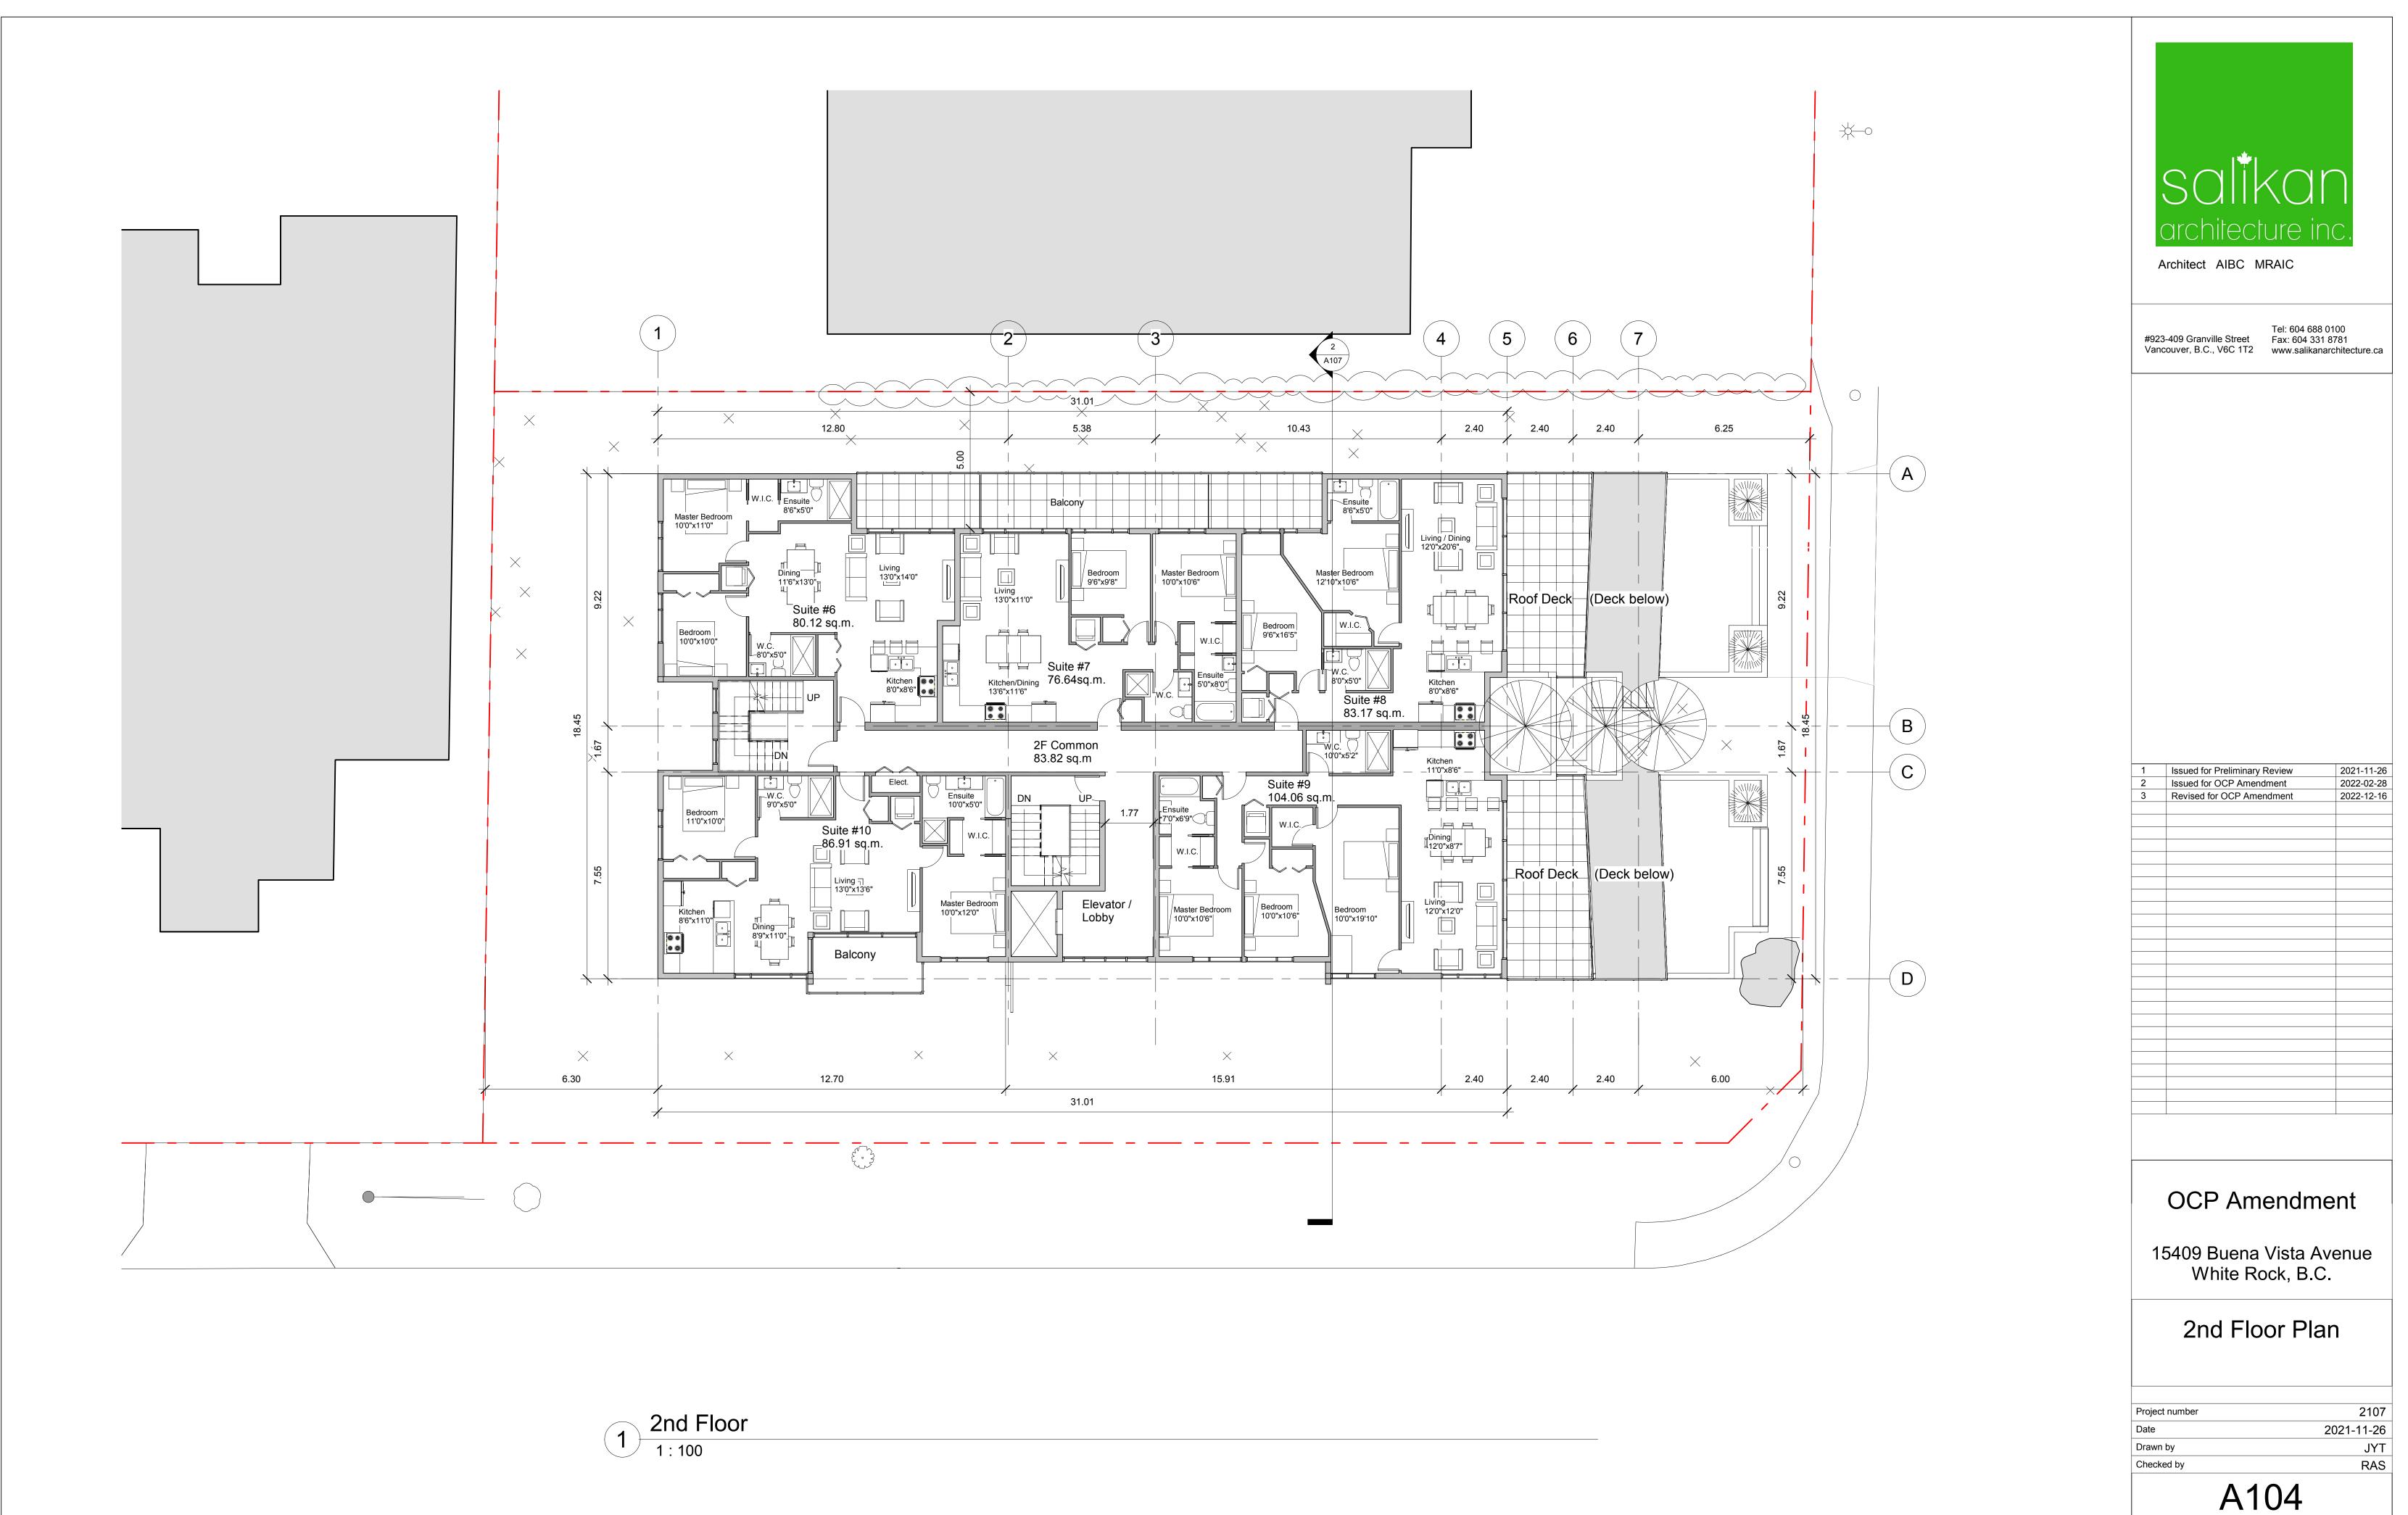

Section 1

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2107 **Date** 21-11-26 Project number **Description**Issued for Preliminary Review 2021-11-26 OCP 22-02-28 22-12-16 Issued for OCP Amendment JYT Drawn by Revised for OCP Amendment Amendment Checked by RAS Section 1 & Section Through Driveway #923-409 Granville Street Vancouver, B.C., V6C 1T2 A107 15409 Buena Vista Avenue White Rock, B.C. Tel: 604 688 0100 Fax: 604 331 8781 www.salikanarchitecture.ca Architect | AIBC | MRAIC 1:100
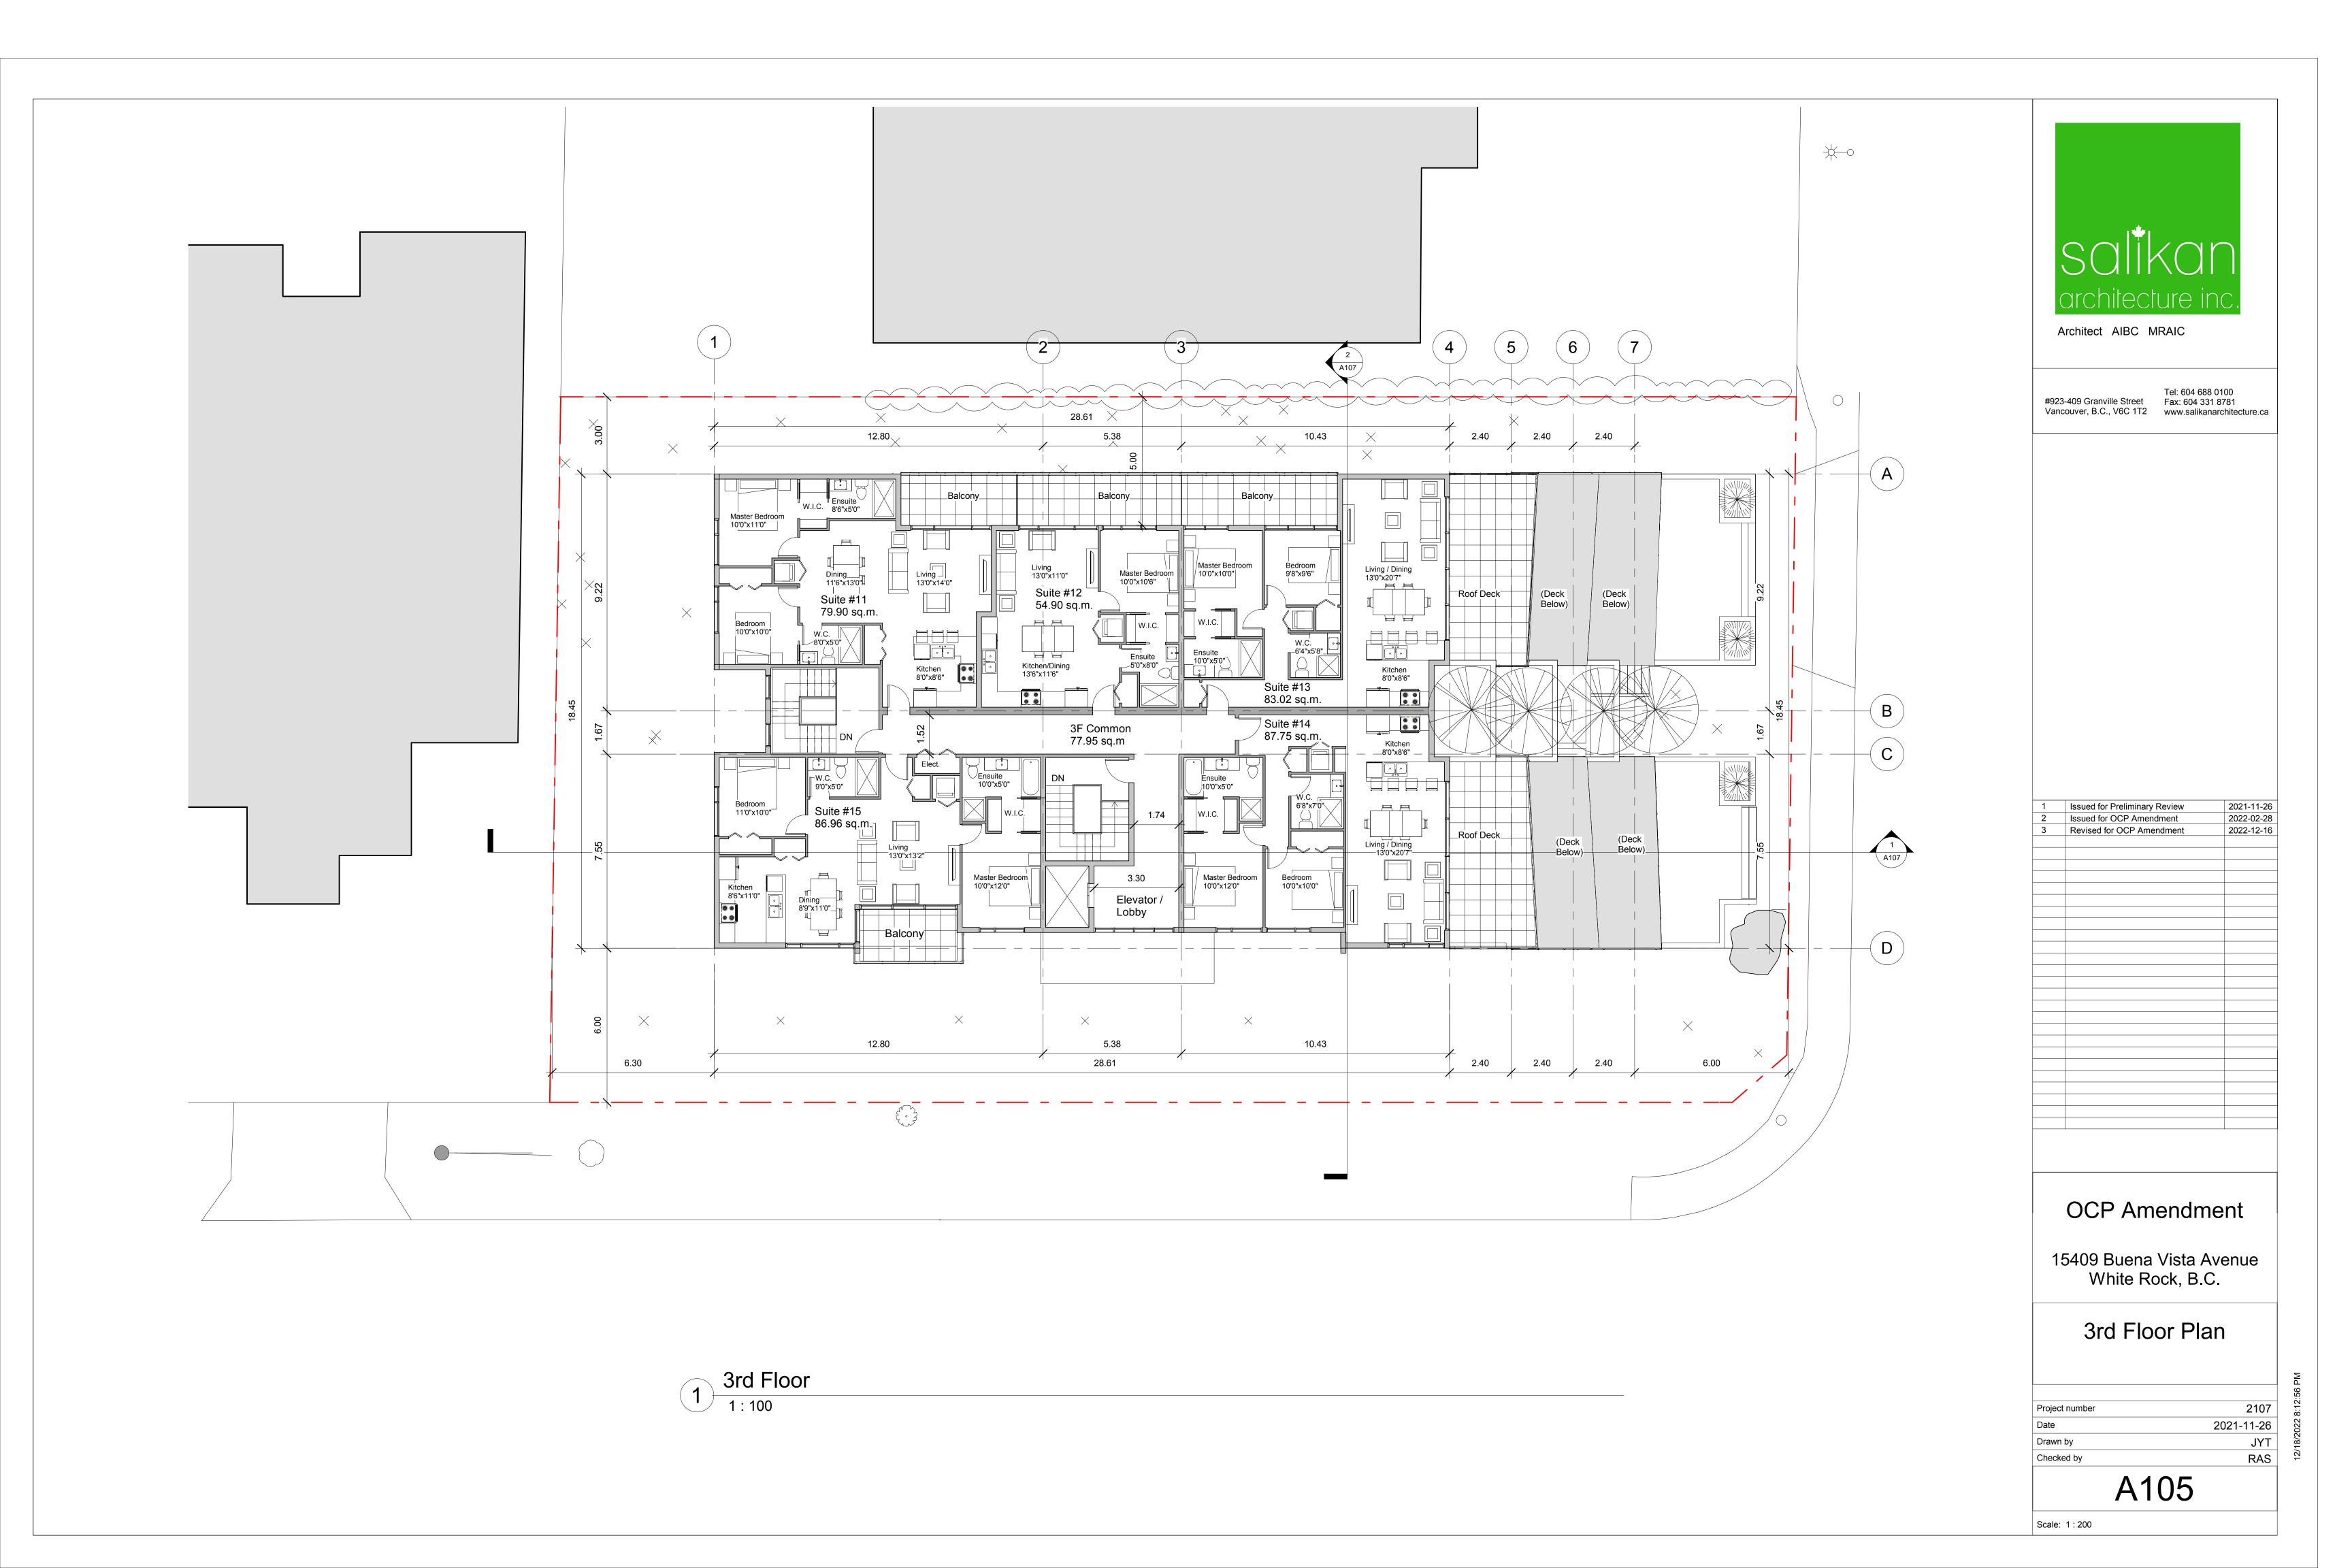
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3D View - NE



3D View -SW



2 3D View -SE



3D View-NW



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Tel: 604 688 0100 #923-409 Granville Street Fax: 604 331 8781 Vancouver, B.C., V6C 1T2 www.salikanarchitecture.ca

1Issued for Preliminary Review2021-11-262Issued for OCP Amendment2022-02-283Revised for OCP Amendment2022-12-16

OCP Amendment

15409 Buena Vista Avenue White Rock, B.C.

3D Massing Views

Project number 2107

Date 2021-11-26

Drawn by Author

Checked by Checker

A109

Scale: 1:200

ATTACHMENT C



Arborist Report

Inventory and Assessment of Trees Associated to Construction at 15409 Buena Vista Avenue, White Rock

March 22, 2022

Adrian Szabunio, Diploma in Civil Engineering Technology ISA Certified Arborist and Tree Risk Assessor PR 5079A

Assignment and Methodology

Woodridge Tree has been retained to undertake an inventory and assessment of trees associated with the demolition and construction of a house at 15409 Buena Vista Avenue, White Rock. The objective is to make tree preservation and protection recommendations in the context of municipal permits, rules and regulations for development.

Associated trees were visually assessed to determine species, diameter at breast height (dbh) and characteristic description. Tree diameters were measured at 1.4 meters height with a diameter tape. Protection areas were calculated for all trees within range of the property. Tree hazards were assessed according to International Society of Arboriculture standards using the TRAQ (Tree Risk Assessment Qualification) method. Recommendations for removal or retention are based on assessment outcome and proximity of trees to structure and infrastructure. Soil testing, root exploration and internal probing of tissue have not been incorporated in the findings.

The observations recorded are based on inspections performed on March 21, 2022. The weather at that time was rainy and approximately six degrees Celsius.



aerial image of property before redevelopment

Findings

The property at 15409 Buena Vista Avenue is located on the North side of Buena Vista Avenue, near the intersection of Best Street and Buena Vista Avenue. At the time of observation a residential house stood on the lot. Associated trees were comprised of native conifers and deciduous species. Trees located on the subject property, City property and neighbors trees close to the property lines are considered in the findings of this report.



image of property from street at time of field data collection

Tree Inventory and Assessment

tag 432	species Ilex aquifolium Holly	dbh 16+ 23= 39cm	description Single stem tree to 1.2m then splits into twin codominant leaders. Canopy is vigorous, and has light deadwood on the interior. Live Crown Ratio: 70% Crown Radius: 2m Height: 3m Its TPZ is 2.34m	action Remove Tree conflicts with proposed building footprint
tag ci1	species Thuja plicata Western Red Cedar	dbh 110cm	description Twin stems fused together from base with no separation between the stems until approximately 2m high. Canopy is raised above the overhead power lines and has light deadwood on the interior. The top has multiple leaders with included bark unions. Live Crown Ratio: 55% Crown Radius: 3.8m Height: 10-12m Its TPZ is 6.60m	action Retain Install a tree barrier 6.60m from the tree. Arborist supervision recommended for building/parkade excavation. Excavation comes 2.89m from the base of the tree.

Summary Table

	subject property	off-site	City property
# of trees in total	1	0	1
# to be removed	1	-	0
# to be protected	0	-	1

Images



IMAGE 1- Tree ci1



IMAGE 2- Tree #432



IMAGE 3- Holly Hedge along Best Street. To be removed



IMAGE 4- Smaragd hedge along East of property. A portion to be removed.



IMAGE 5- Undersize tree



IMAGE 6- Undersize tree



IMAGE 7- Cedar hedge on East side of property. A portion to be removed.



IMAGE 8- Smaragd hedge near existing garage. To be removed.

Conclusion

Property, plans and trees have been assessed by arborist to determine tree management recommendations for construction. Those recommendations follow:

Recommended Tree Removals:

- Tree #432- Tree conflicts with proposed building footprint.
 - The Smaragd hedge mid lot is recommended for removal, its location conflicts with the building footprint.
 - It is recommended to remove a portion of the hedge on the East side of the property as the excavation for the parkade will conflict with the location of the hedge.
 - It is recommended to remove the hedge along the West property line to accommodate the entry was along the West side of the building

Recommended Tree Protection:

- Tree barriers shown on the "Tree Plan for Construction" are to be installed and kept in place during the entire duration of construction.
 - Arborist supervision recommended for building/parkade excavation within TPZ of tree ci1.

Limitations and Assumptions

- This report was prepared for and on behalf of the client and it is intended solely for their use. Woodridge Tree Consulting Arborists Ltd. shall not accept any liability derived from the partial, unintended, unauthorized or improper use of this report.
- This report is restricted to the subject trees as detailed in the report. No other trees were inspected or assessed as part of the work related to the preparation of this report.
- The accuracy and ownership of the locations of trees, property lines and other site
 features were not verified by Woodridge Tree. Third party information to the consultant
 may have been relied upon in the formation of the opinion of the consultant in the
 preparation of this report, and that information is assumed to be true and correct.
- The use of maps, sketches, photographs and diagrams are intended only as a reference for the readers use in understanding the contents and findings of this report, and are not intended as a representation of fact.
- Approvals from a municipal or senior government agency may be required in relation to certain recommendations and treatments provided in this report. The owner is responsible to make application for, pay related fees and meet all requirements and conditions for the issuance of such permits, approvals or authorizations.

I certify to the best of my knowledge or belief that:

- staff from this firm have performed site inspections on the dates as stated herein.
- the findings are based on information known to the consultant at that time.
- the statements of fact determined by the consultant are true and correct.

If there are questions regarding the contents of this report please contact our office.

Adrian Szabunio

Diploma in Civil Engineering Technology

ISA Certified Arborist

ISA Tree Risk Assessment Qualified


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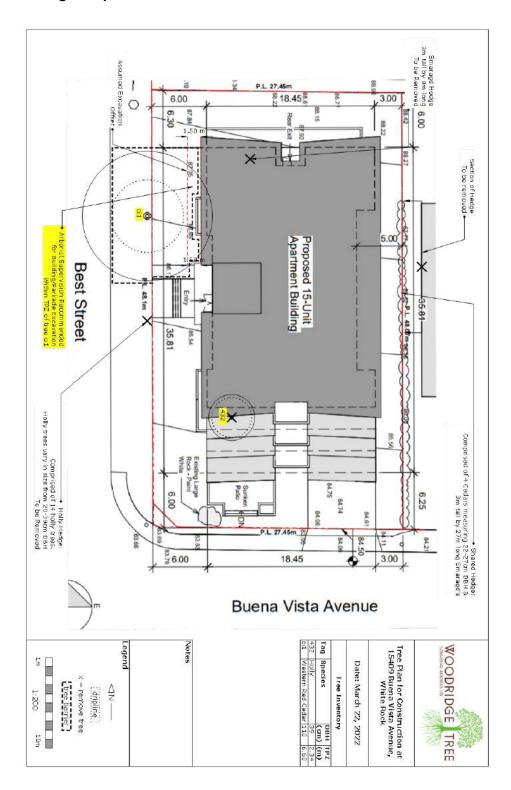
Woodridge Tree Consulting Arborists Ltd.

adrian@woodridgetree.com


Existing Site



Proposed Building Footprint Plan

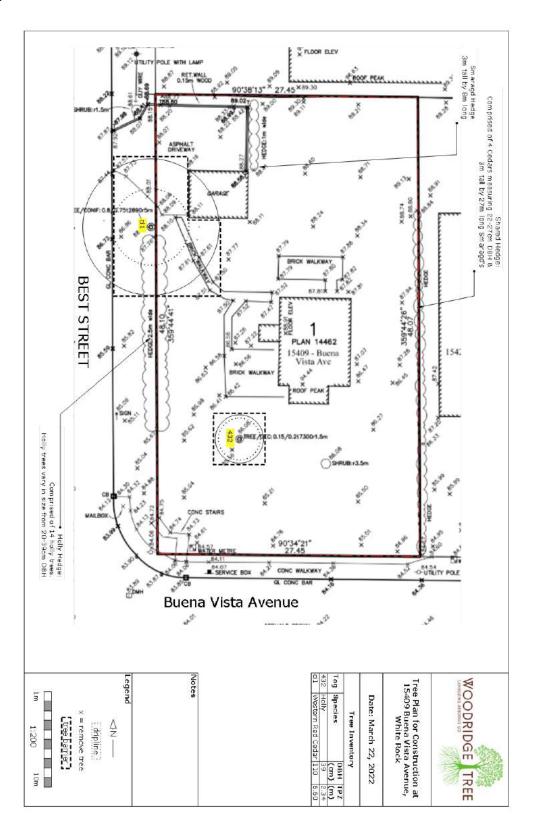

Proposed Building Parkade Plan

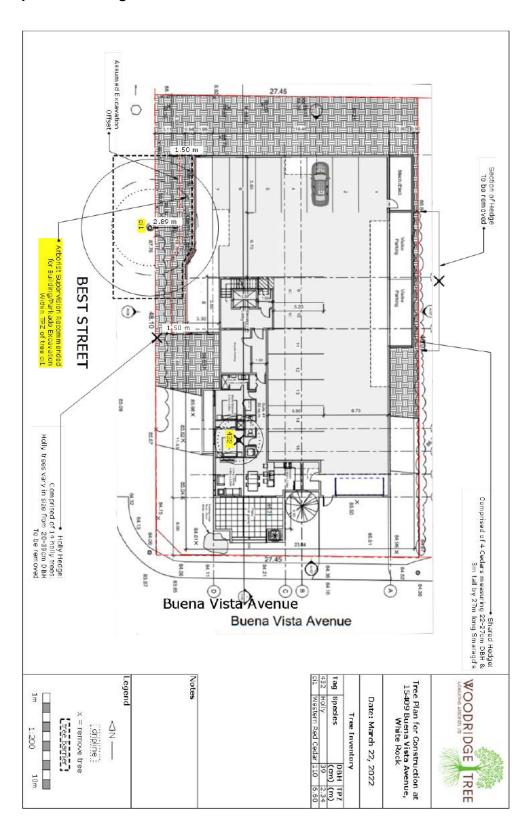

Replacement Plan

