
#### **ATTACHMENT A**

#### 1590 Lancaster Street

(City File: 22-038)

- Location Map and Ortho Map (illustrating the location and context of the property)
- Topographic Survey
- Applicant's Design Rationale
- Architectural Drawings and Renderings
- Arborist Report

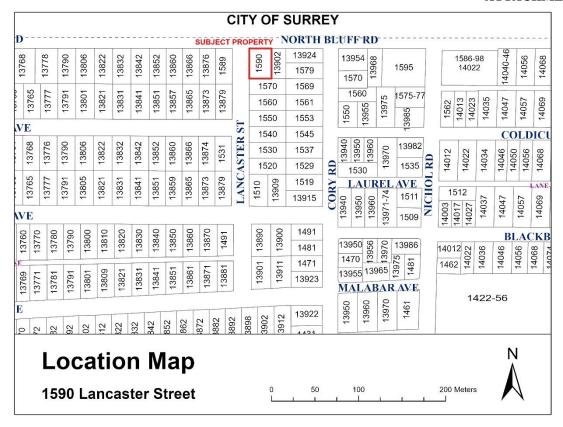



#### TOPOGRAPHIC SITE PLAN OF PARCEL "A" (EXPLANATORY PLAN 36486) LOTS 46 AND 47 SECTION 9 TOWNSHIP 1 NEW WESTMINSTER DISTRICT PLAN 26130 CIVIC ADDRESS: 1590 Lancaster Street, White Rock P.I.D. 004-750-187 SCALE 1 : 250 ALL DISTANCES ARE IN METRES NORTH BLUFF ROAD 120 coniferous O 60 coniferous (1) мѕ⊙ STREET PLAN 26130 (EXP. PLAN 36486) & 47 LOT AREA=893.8 Sq.m. PLAN 26130 <u>LEGE</u>ND DENOTES FIRE HYDRANT DENOTES CATCH BASIN - TOP ENTRY ⊘ CB DENOTES CATCH BASIN - ROUND DENOTES UTILITY POLE DENOTES UTILITY POLE WITH TRANSFORMER DENOTES UTILITY POLE WITH LIGHT ₩ W DENOTES WATER VALVE DENOTES WATER METER SRW-(345809C) SOUTH, 6: DENOTES GUY WIRE O MHS DENOTES SANITARY MANHOLE 0 O MHD DENOTES STORM MANHOLE 30 deciduous DENOTES TREE AND CANOPY EXTENT DENOTES GROUND ELEVATION DENOTES TOP OF RETAINING WALL ELEVATION DENOTES MULTI-STEMMED TREE Lot dimensions are derived from Field survey 48 PLAN 26130 Elevations are Geodetic (CVD28 GVRD-2018 - IN METERS) Derived from Control Monument 88H3863 located at the intersection of Blackburn Avenue and Lancaster Street. Elevation = 78.490m Invert elevations and offsets of services from property lines are derived from municipal records and field survey. Contractor to verify all service locations and inverts prior to construction. Spot elevations along curb are taken in gutter Tree diameters are taken at 1.4m above grade and are shown in cm. This Plan was prepared for architectural design and permit purposes, and is for the exclusive use of our client. The signatory accepts no responsibility or liability for any damages that may be suffered by a third party as a result of reproduction, transmission or alteration to this document without consent of the signatory.



DATED THIS 5TH DAY OF APRIL, 2022

\_\_\_\_ BCLS

CERTIFIED CORRECT

Finny Philip

#### **Attachment A**



1933 Yukon Ave, Port Coquitlam, BC V3C 0G5

Phone: (604) 614-6627 Email: chris@cvdesigns.ca Website: www.cvdesigns.ca

#### DESIGN RATIONALE FOR TRIPLEX DESIGN FOR 1590 LANCASTER STREET, WHITE ROCK

The proposed triplex development at 1590 Lancaster Street responds to the challenges of environmental sustainability and visual appeal by implementing a combination of following design strategies.

#### Tree preservation:

- The proposed driveway location allows for the retention of all of the trees along North Bluff Road while still providing access to the homes.
- New trees will be proposed surrounding the property to promote privacy and visual appeal from North Bluff Road, and Lancaster Street.

#### Water conservation:

- Permeable pavers have been proposed for all parking pads and walkway areas to promote storm water flow to lane and on-site drainage.
- Drought resistant planting which requires less water.
- Low flow shower heads and dual flush toilets to allow for water conservation inside the house
- Hot water and boiler on demand for hot water system which uses less water.

#### Neighborhood context:

- The archetype of the buildings is Traditional Craftsman which is consistent with the surrounding neighborhood.
- Roof style uses a combination of gables and hip roofs which is consistent with the surrounding neighborhood.
- A lower 4/12 roof slope for the main portion of the upper roofs has been used to limit the shadowing of neighboring properties.
- The exterior finishes uses a combination of horizontal and wall shingle siding with window trims, asphalt shingle roofing and base trims which is consistent with the "Craftsman" style of home and the surrounding neighborhood.

#### Variety in design:

- Strategic articulated wall faces on the front of the buildings will enhance the visual appeal and limit long wall massings.
- Gable roofs will be used on the front facade to enhance the individuality of the units.
- A variety of color choices will assist in differentiating the three units of the triplex.

#### Landscaping:

- The proposed project incorporates landscaping elements on all sides of the property.
- The front yard consists of a single access point for cars and a single permeable paving stone walkway to maximize live landscaping where possible and promote natural drainage.
- The northwest corner features hedging yews to give privacy from North Bluff Road and Lancaster St.
- Boxwoods will be strategically placed around walkways and landscaped areas.
- Drought resistant grass will be used on the North and South sides as well as in the rear yards.

In summary the proposed development incorporates all features discussed above helping to demonstrate how the development will be compliant with the duplex /triplex guidelines for the City of White Rock.

Sincerely,

Christophe Vaissade


# **Attachment A**



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1590 LANCASTER STREET WHITE ROCK BC

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CLIENT:

PROJECT:

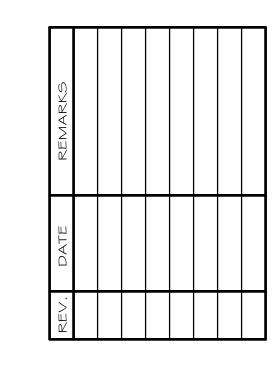1590 LANCASTER STREET, WHITE ROCK

CONTENT:

COVER SHEET

AUG 2022

SCALE:

1/4" = 1'-0"

PROJECT No.:


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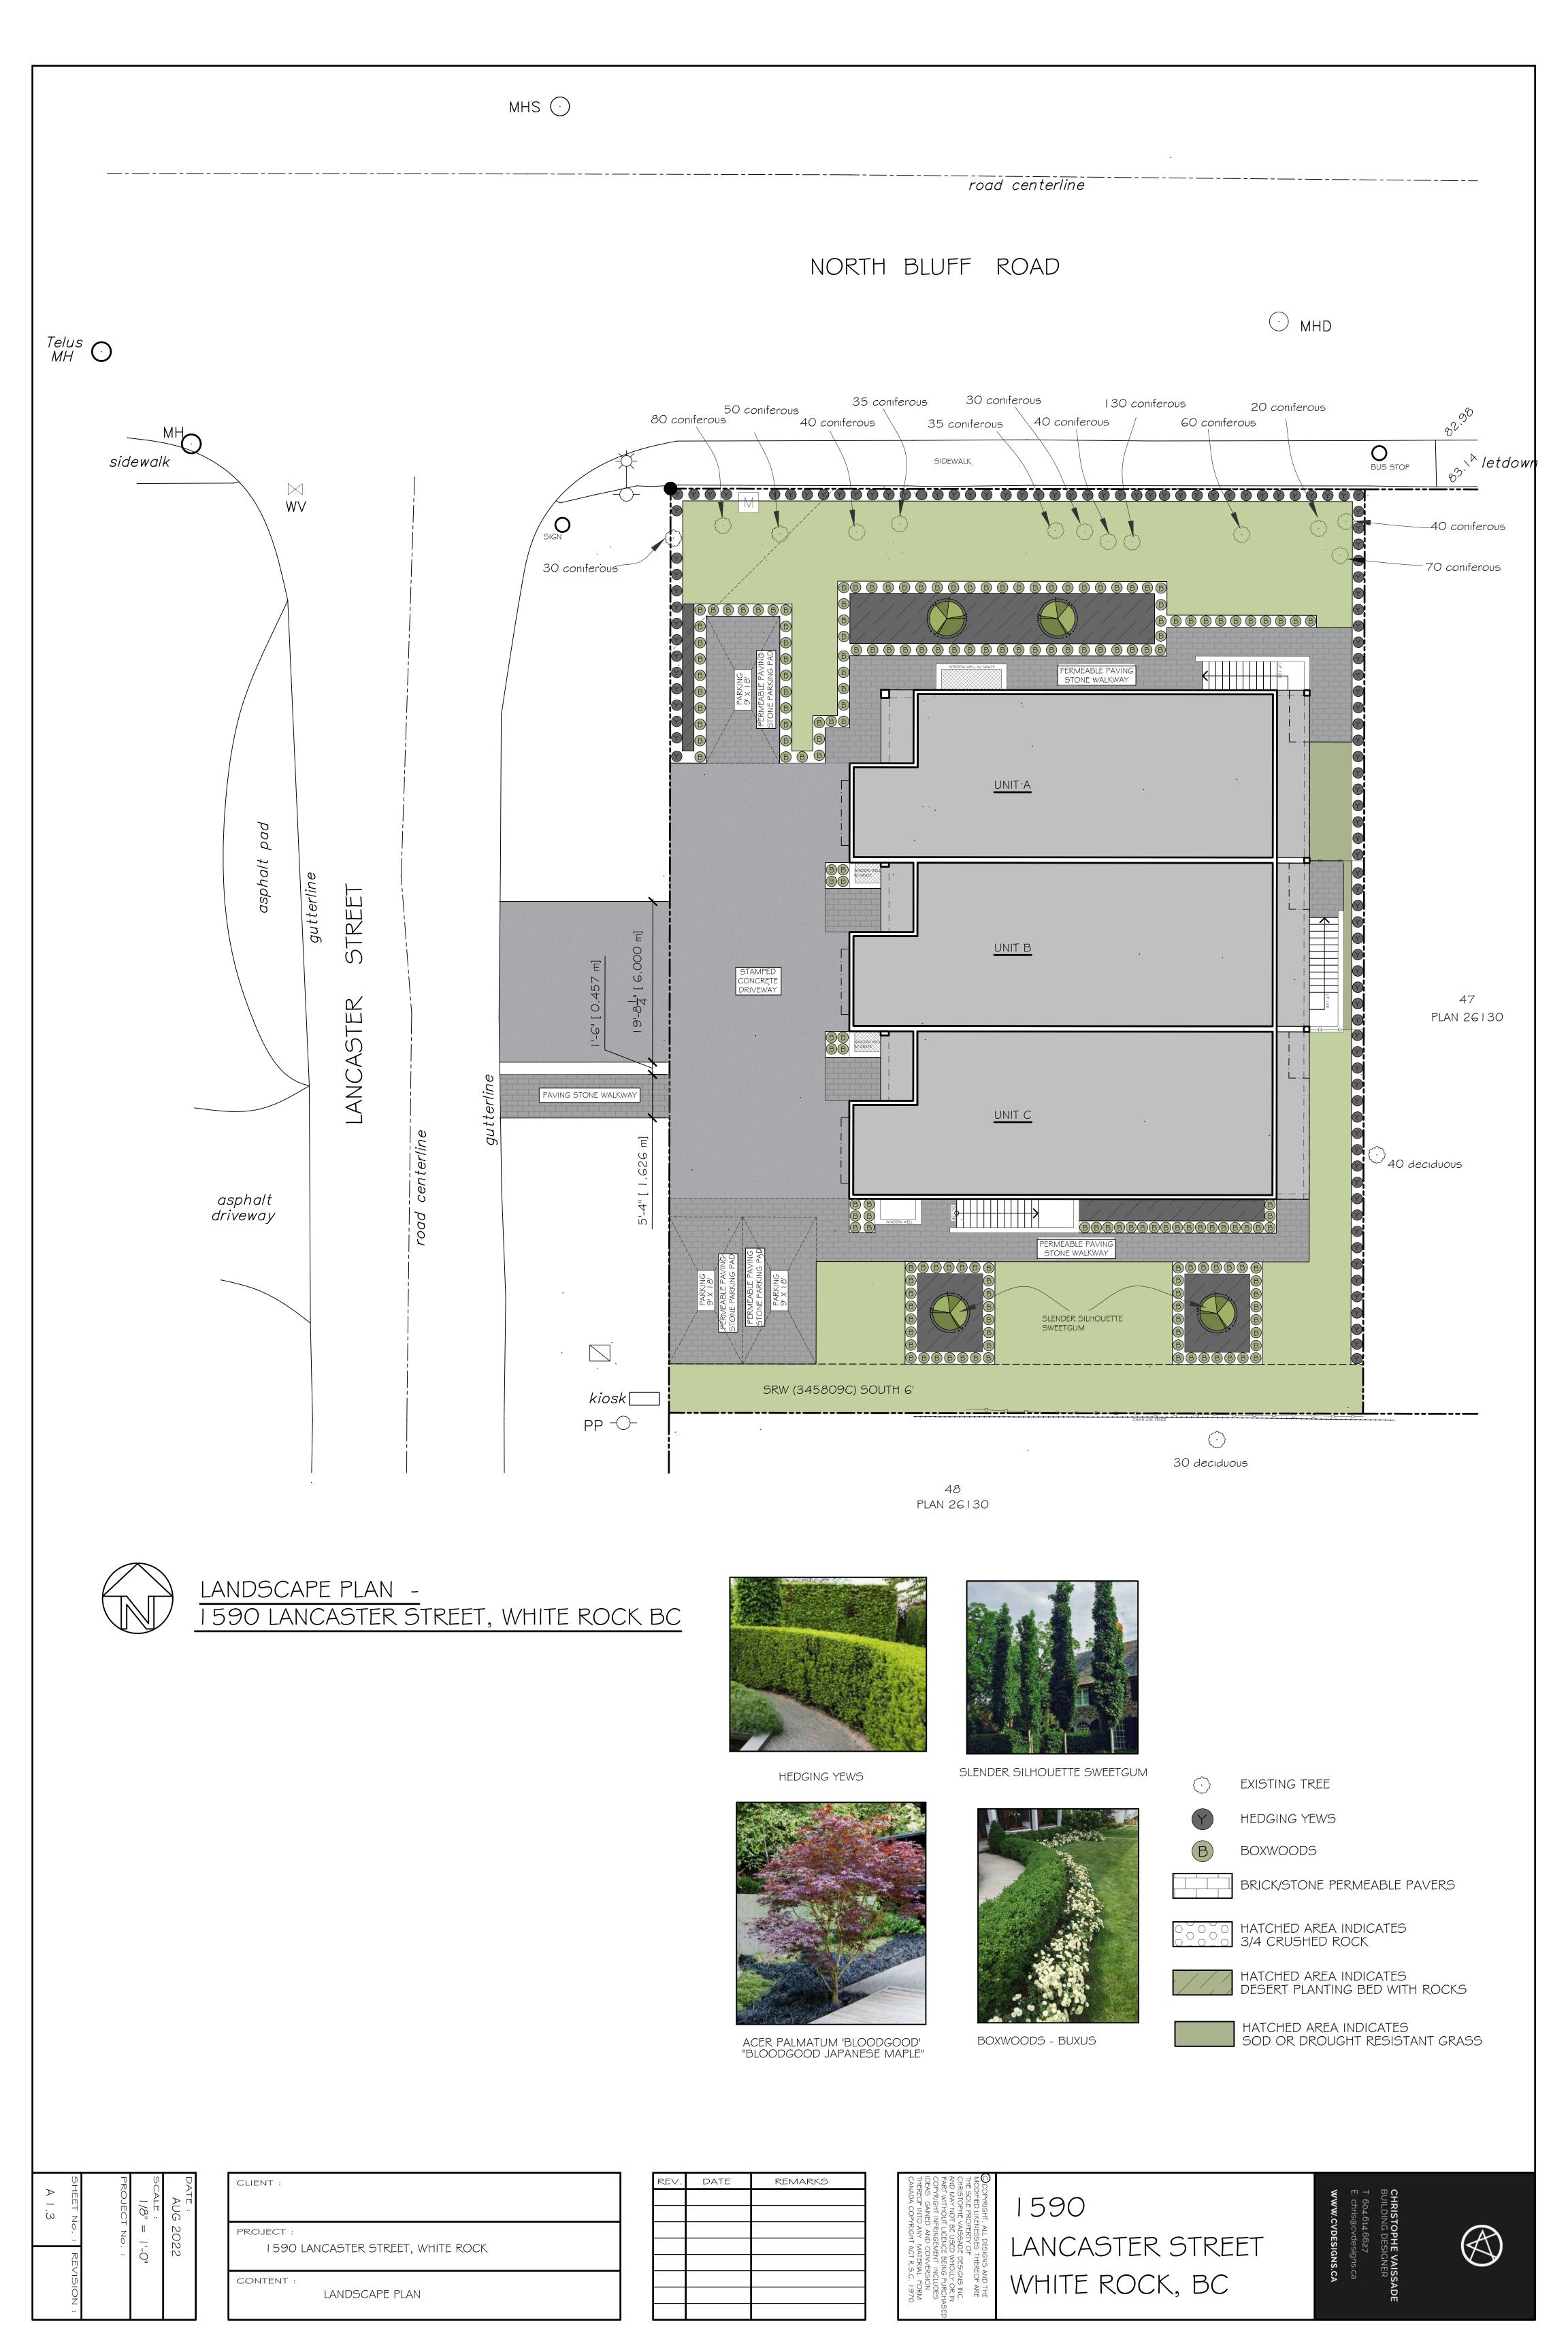



# 1590 LANCASTER STREET, SURREY BC

### DRAWING INDEX

	DRAW	ING	INDEX
SH	IEET NO.	CONTE	NTS
ΑΙ	.1	COVER	SHEET
ΑΙ	.2	SITE PL	.AN
ΑΙ	.3	LANDS	CAPE PLAN
A2	2.1	FLOOR	PLANS
A2	1.2	FLOOR	PLANS
A2	2.3	FLOOR	PLANS
АЗ	5.1	ELEVAT	IONS
АЗ	5.2	ELEVAT	IONS



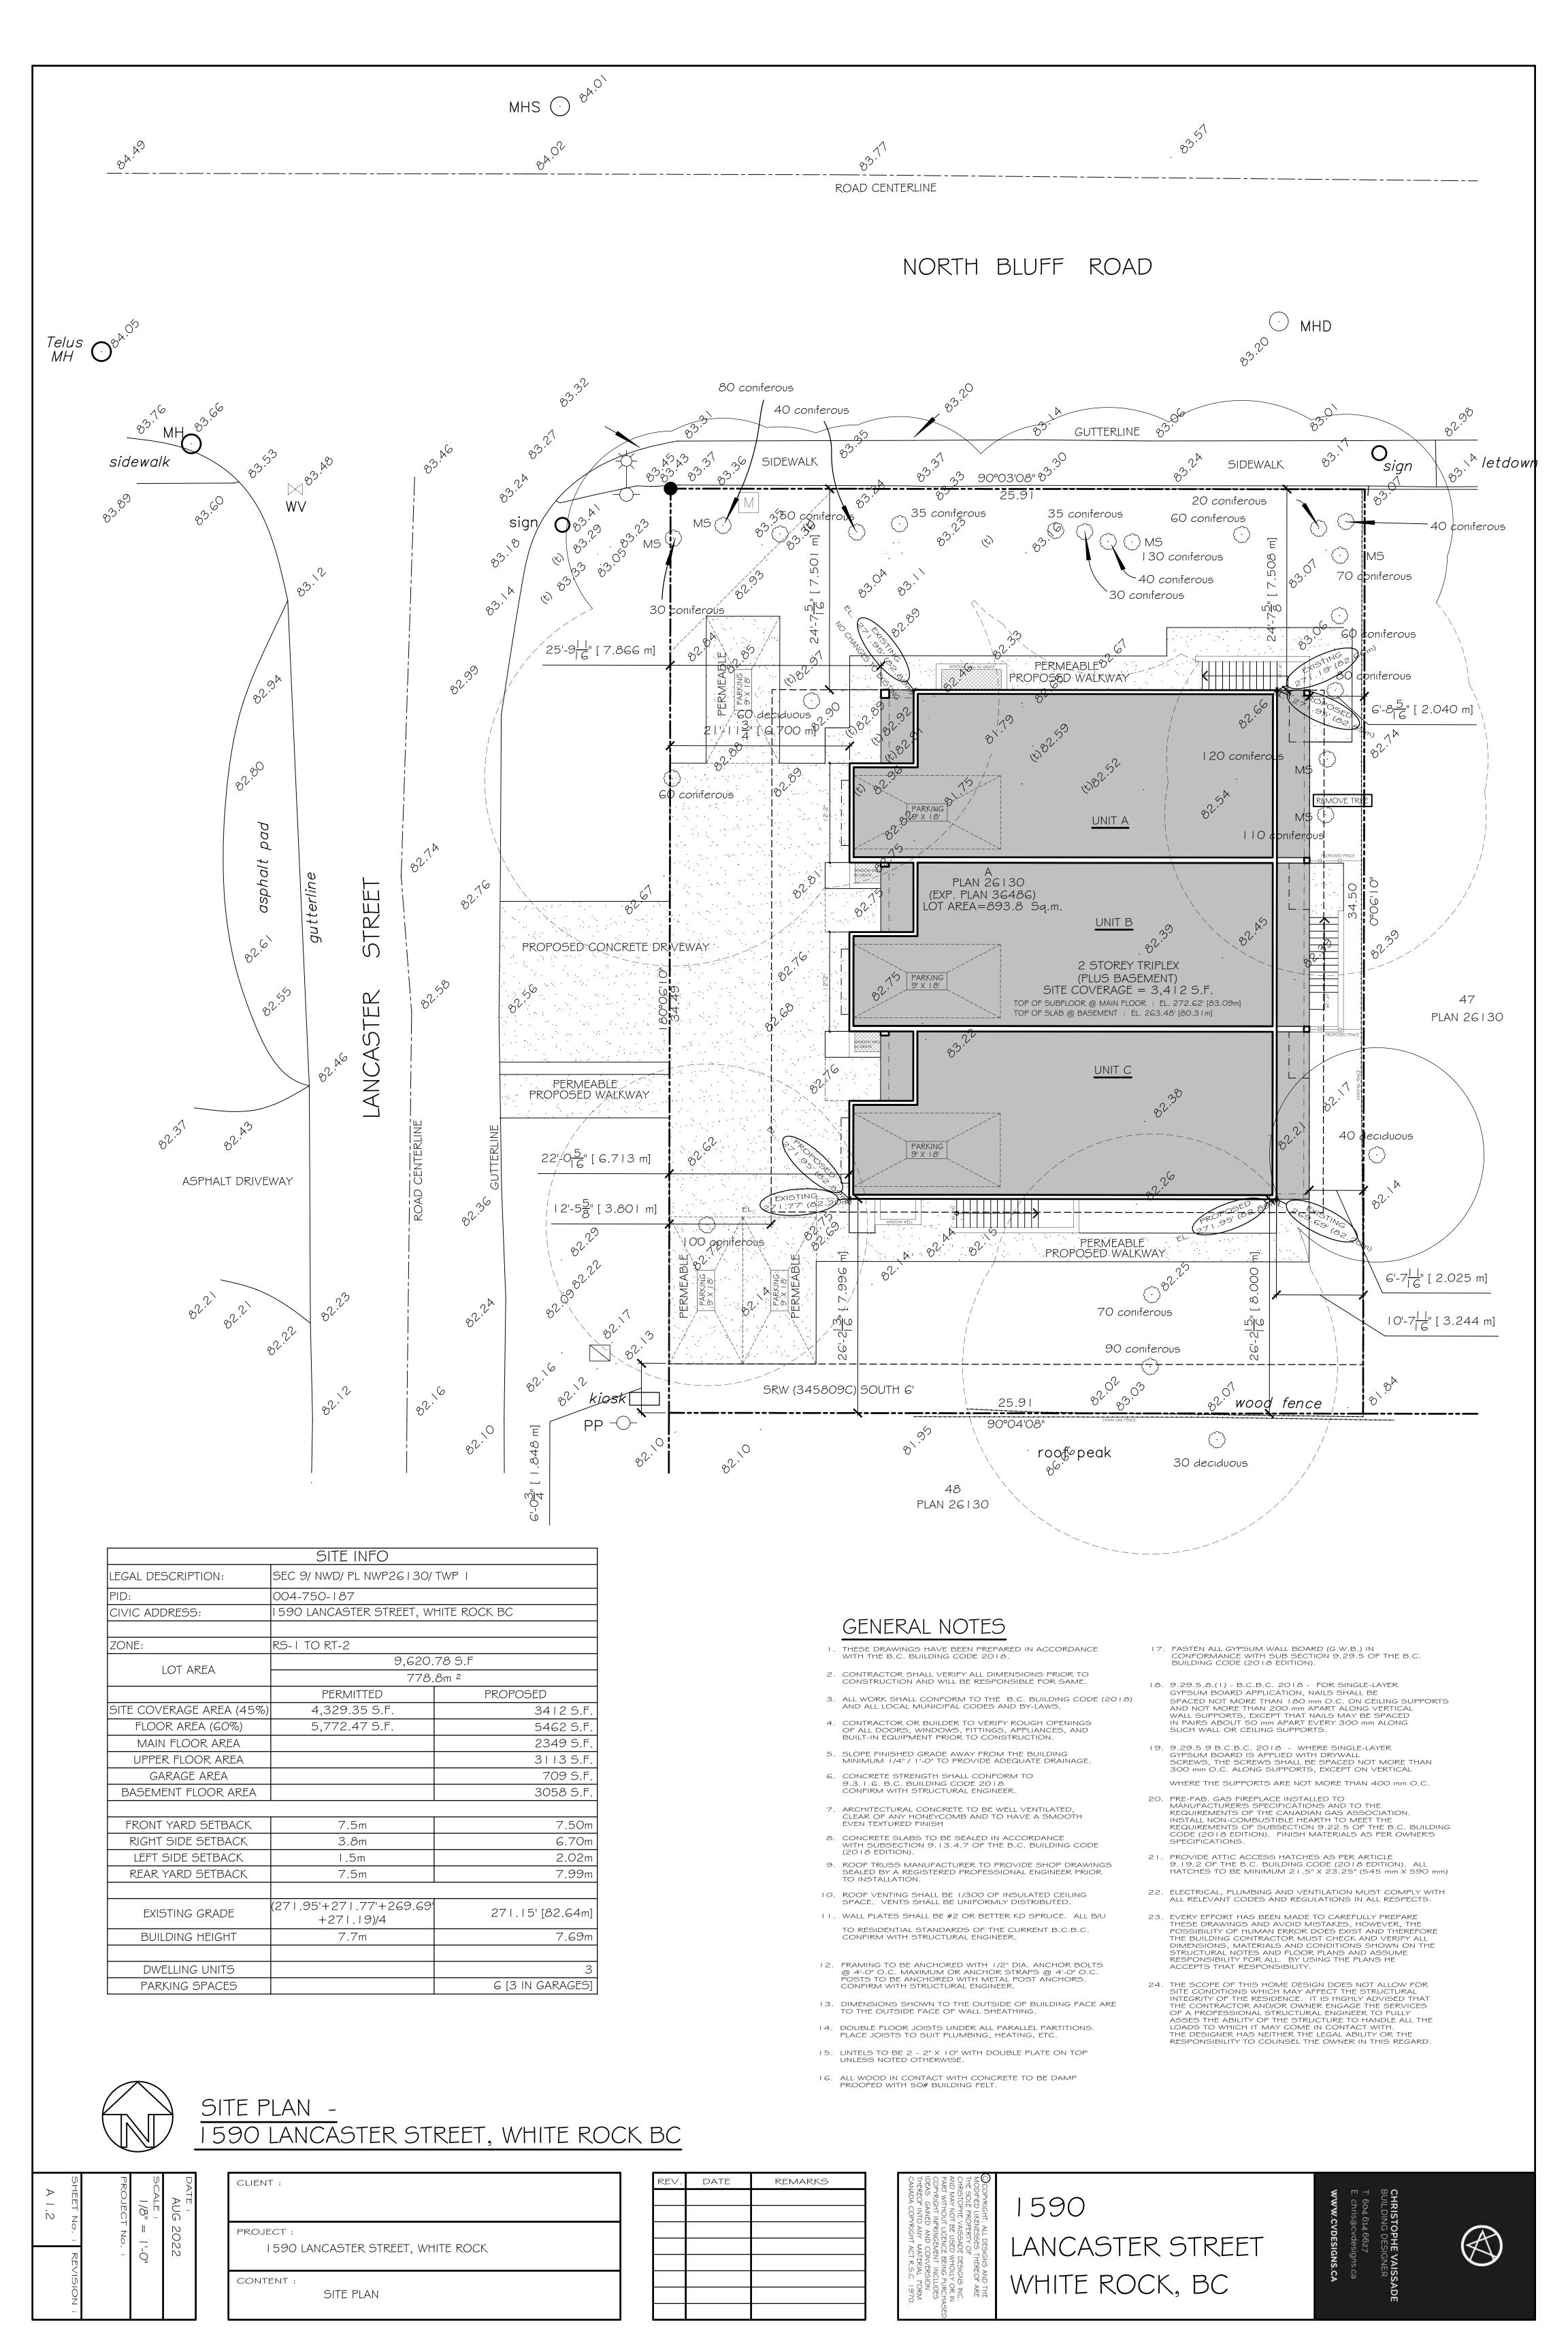

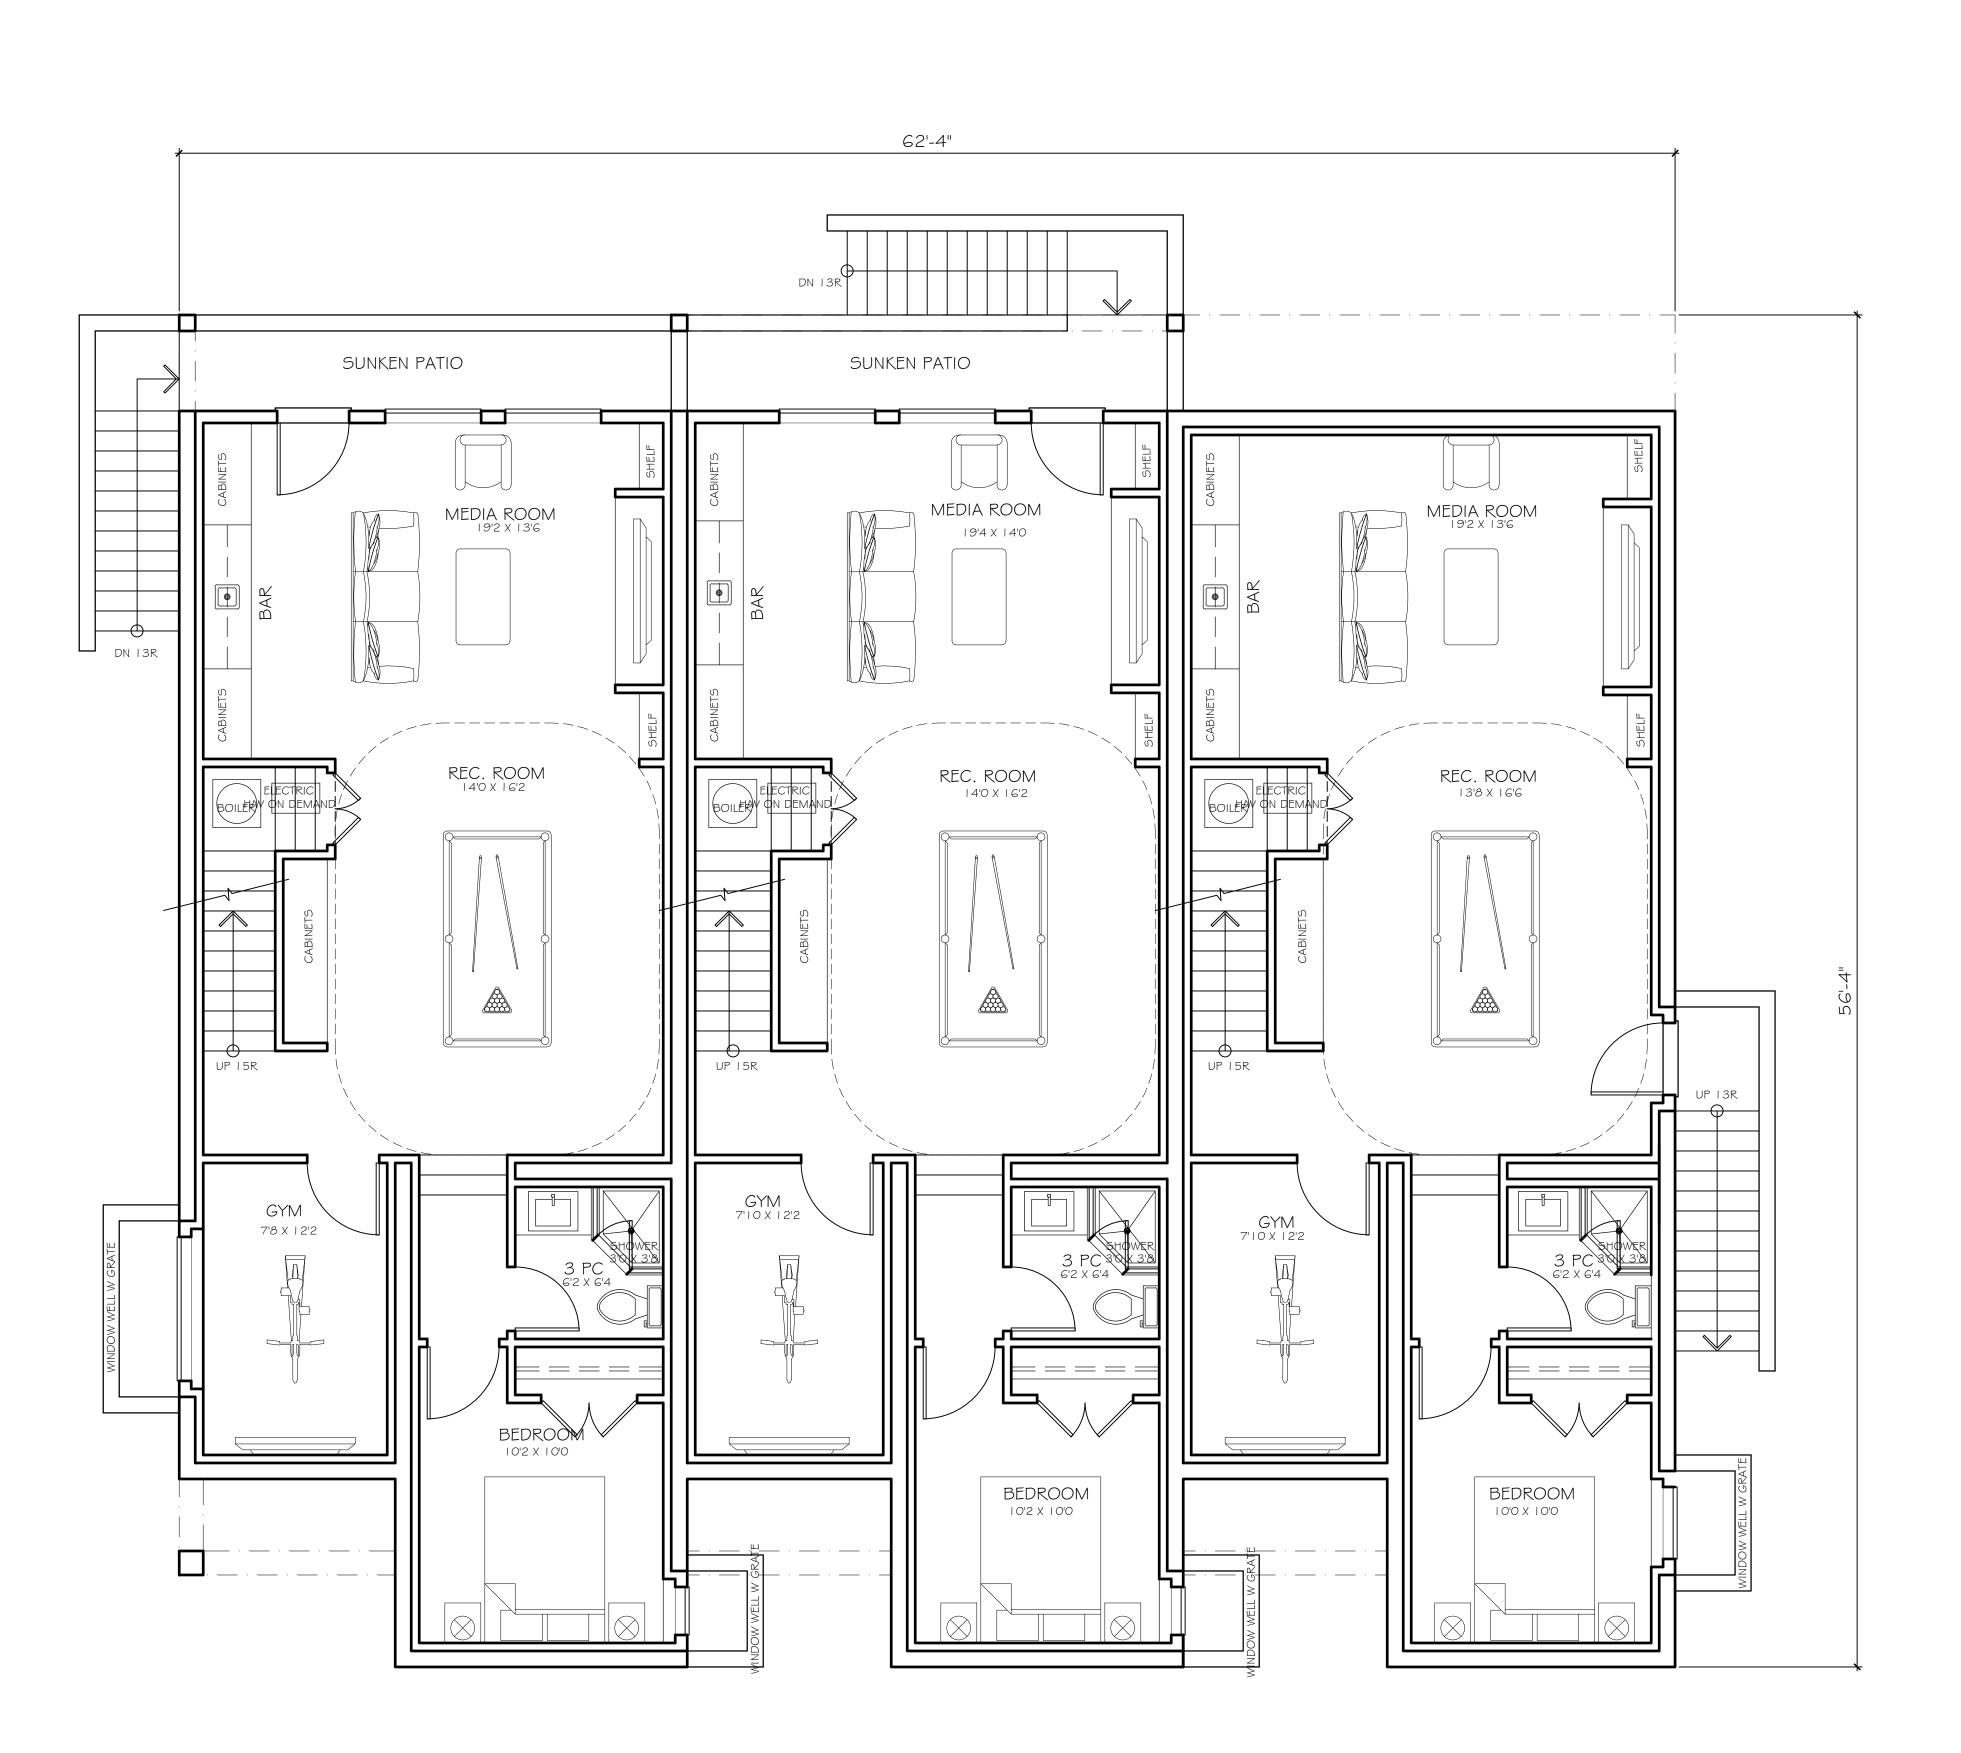

BASEMENT FLOOR PLAN

BASEMENT FLOOR AREA

3058 S.F.




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1590 ANCASTER STREET

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CLIENT:

PROJECT:

1590 LANCASTER STREET, WHITE ROCK

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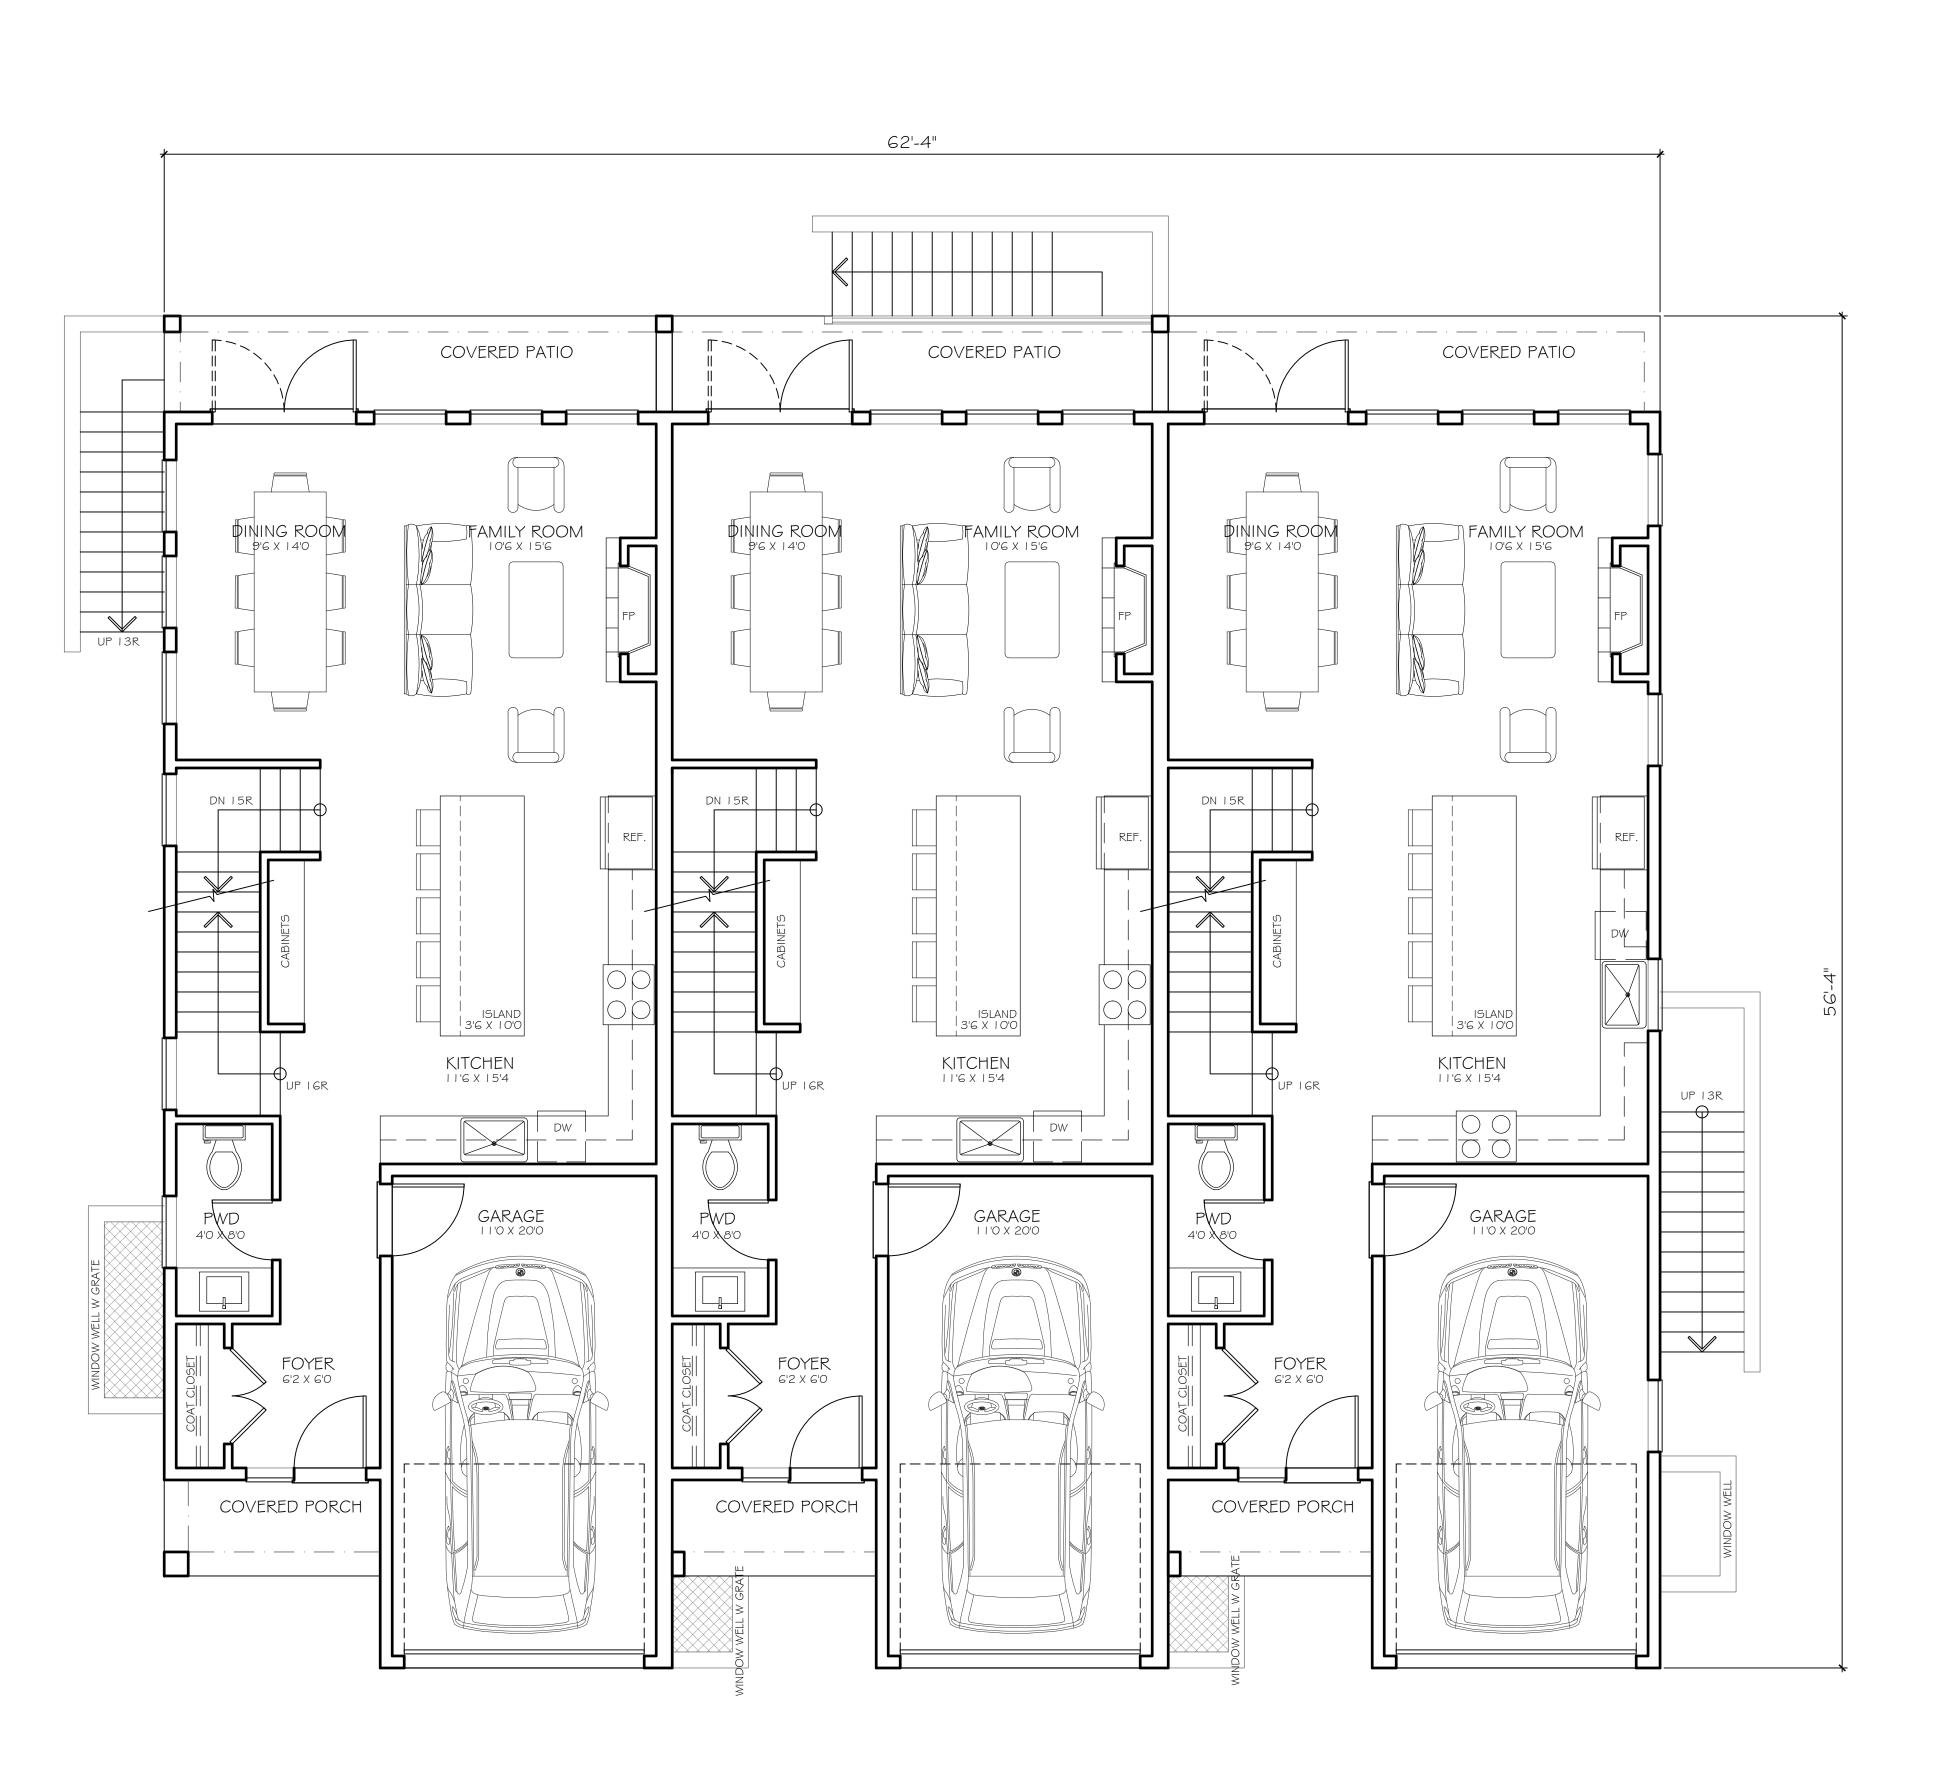
FLOOR PLANS

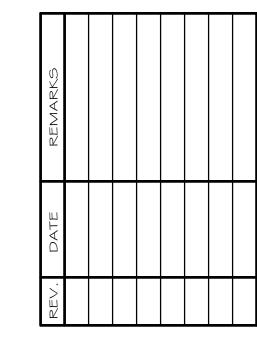DATE :
AUG 2022

SCALE :

| /4" = |'-0" | PROJECT No. :

SHEET No. : REVISION :



# MAIN FLOOR PLAN

MAIN FLOOR AREA GARAGE AREA GROSS FLOOR AREA 2349 S.F. 709 S.F. 3080 S.F.

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AUG 2022

1/4" = 1'-0"

SHEET No. : REVISION

PROJECT No.:

SCALE :

A 2.2

CHRISTOPHE VAISSADE BUILDING DESIGNER

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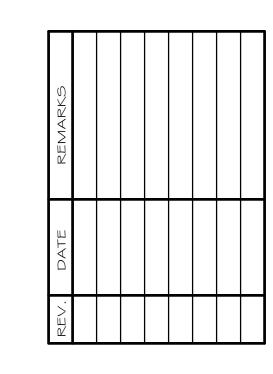
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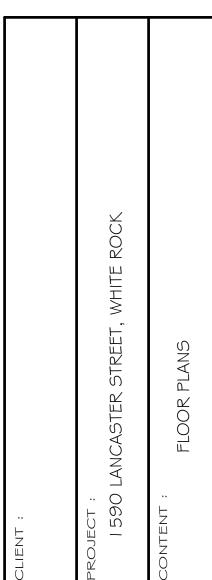






# 1590 LANCASTER STREE

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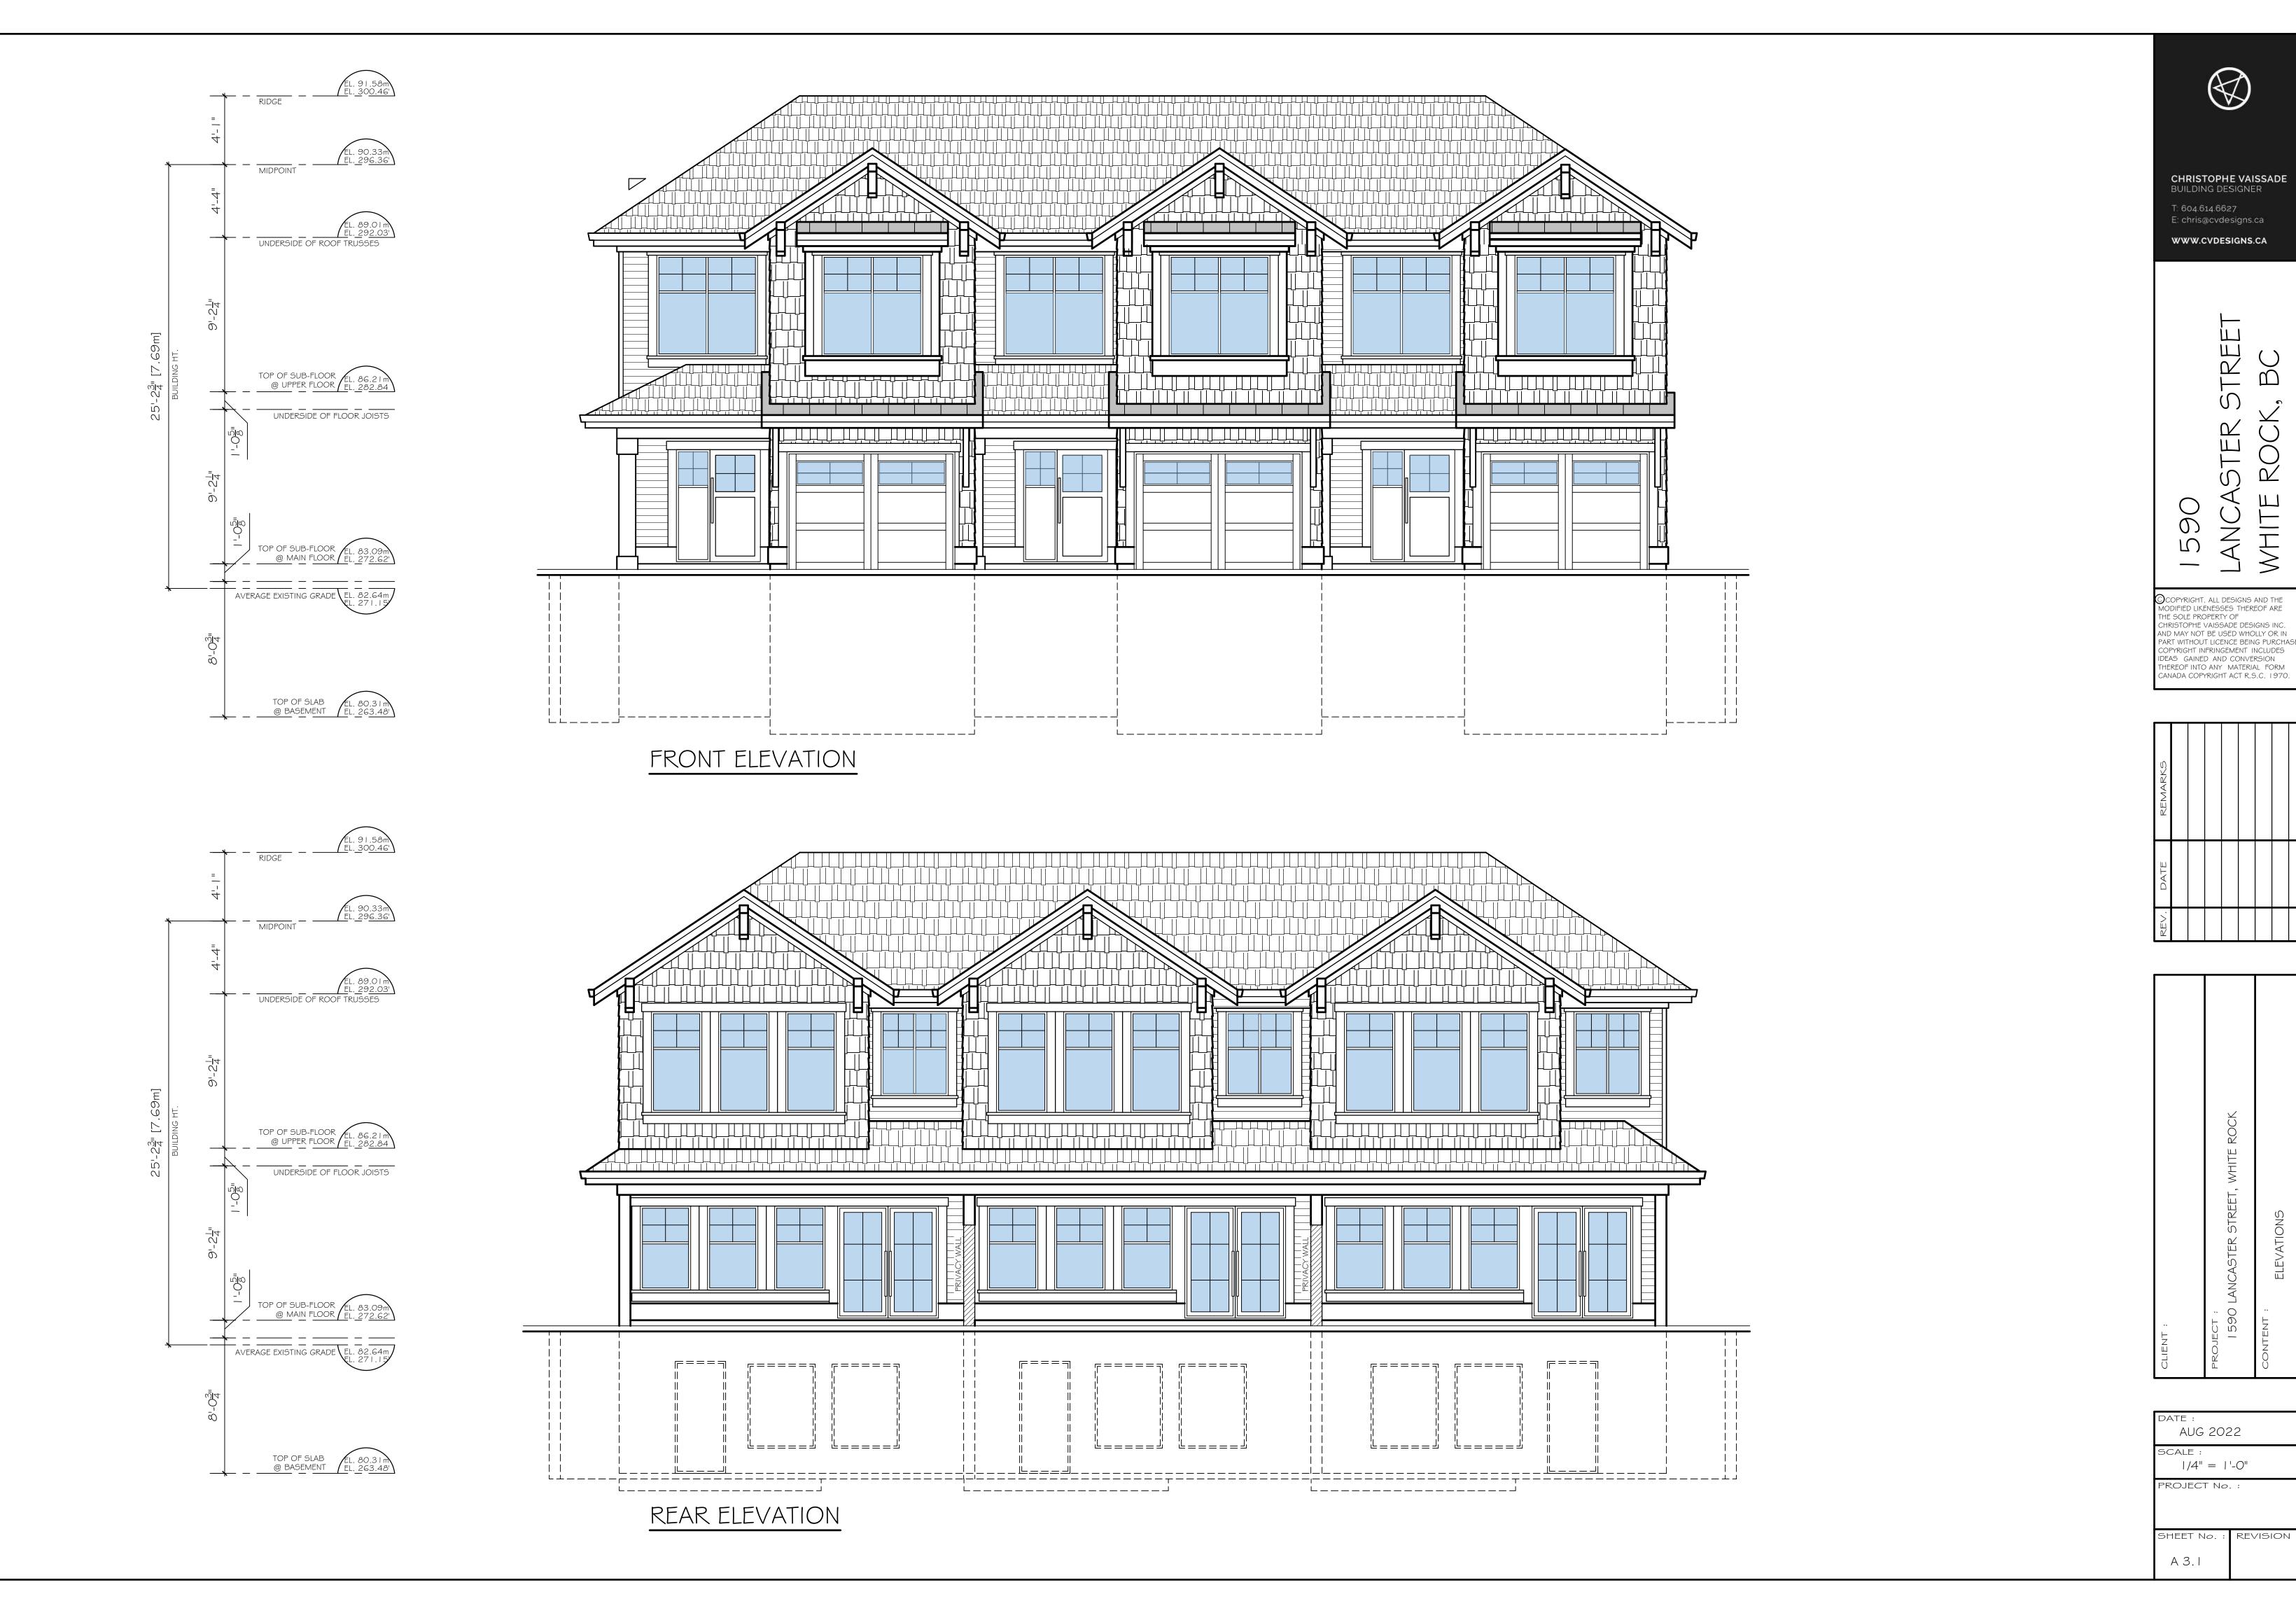




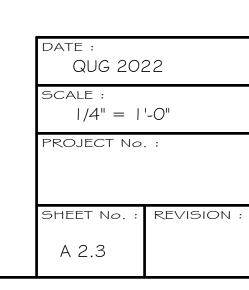

# UPPER FLOOR PLAN

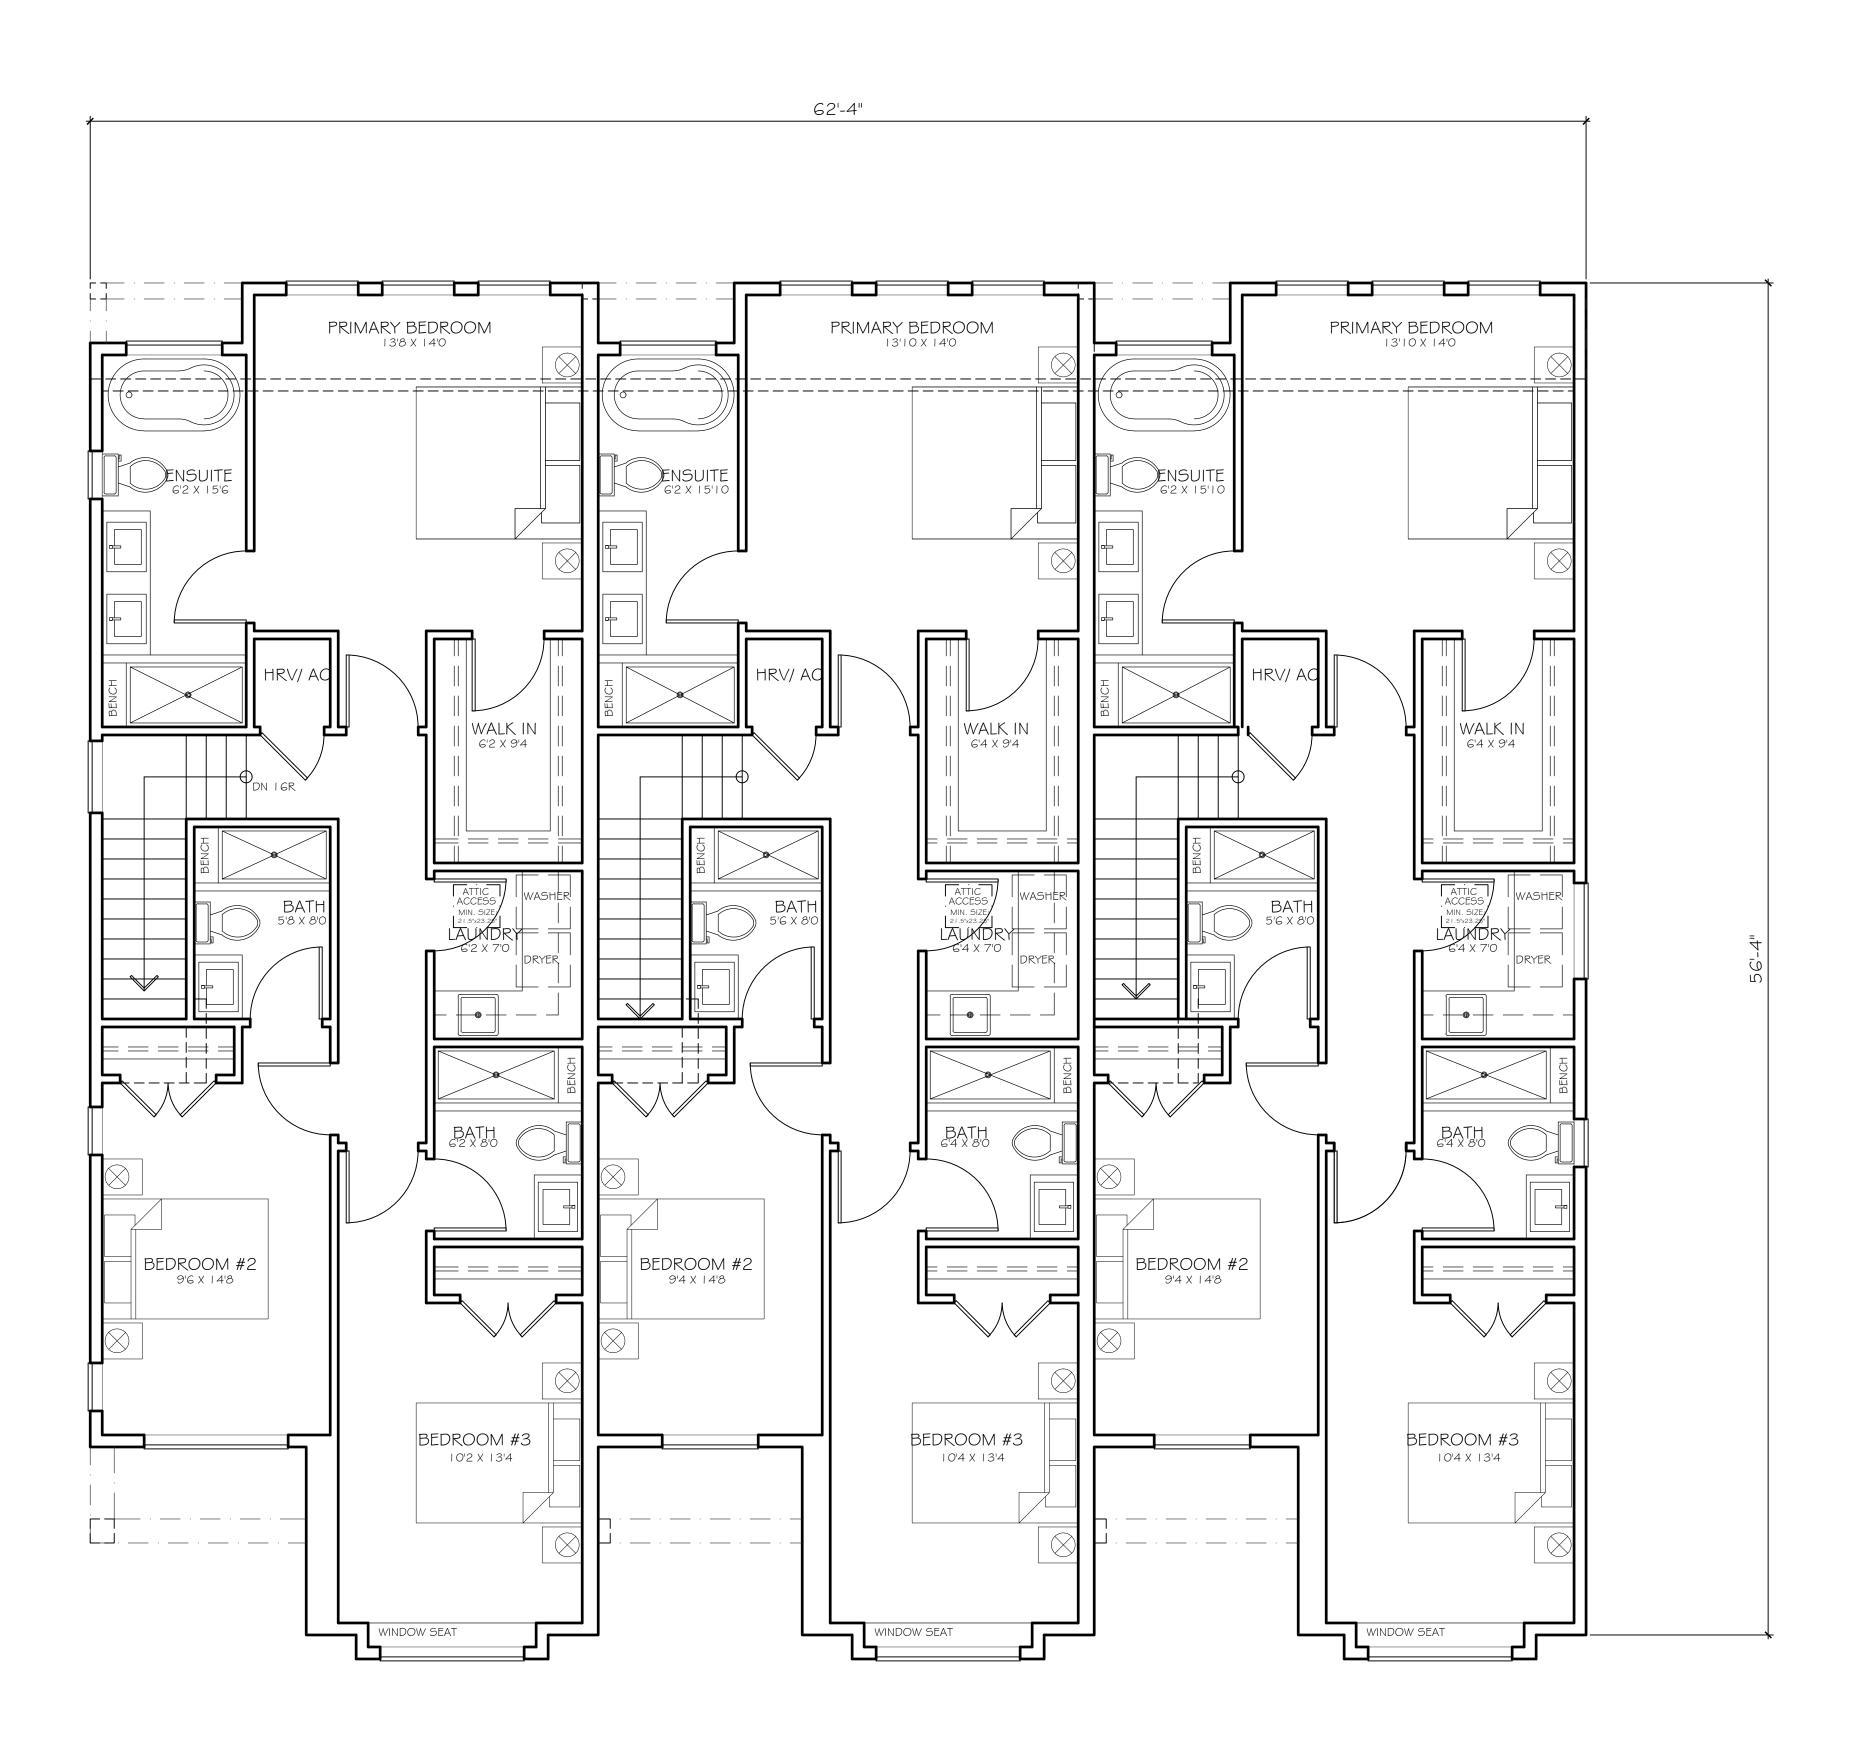UPPER FLOOR AREA3113 S.F.STAIRS150 S.F.GROSS FLOOR AREA3287 S.F.







CHRISTOPHE VAISSADE
BUILDING DESIGNER


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FR STREET

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DATE :
AUG 2022

SCALE : |/4" = |'-0" PROJECT No. :

SHEET No.: REVISION
A 3.2

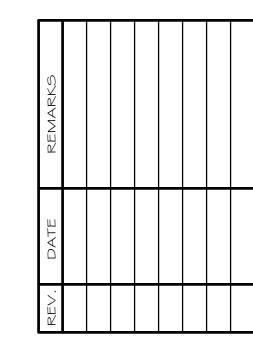

# Arborist Report for Development 1590 Lancaster Street White Rock, BC V4B 3H4

August 17, 2022

Submitted to:

City of White Rock
Planning & Development Services Department

Submitted by:

Freedom Sukenick
ISA Certified Arborist PN 7712A
White Rock Business License #23377

Client:

Uppal Bro's Homes
Garry Dusanjh/Jaspal Uppal
778-952-3096
gdusanjh@hotmail.ca

#### **TABLE OF CONTENTS**

Assignment/Introduction	Page 3
Methodology	Page 3
Observations	Page 4
Table 1 - Tree Inventory and Assessment	Page 5
Summary and Recommendations	Page 9
Table 2 - Tree Protection Summary	Page 10
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Photos	Page 11
Tree Survey Drawings	Page 13
Assumptions, Limiting Conditions and Certification	Page 15

If there are any questions or concerns with the contents of this report, please do not hesitate to contact us.

#### Contact information

Phone: 604-306-6942

Email: info@freedomtreecare.com

Website: www.freedomtreecaretrimmingservice.com

#### **ASSIGNMENT / INTRODUCTION**

I was asked to assess all trees located onsite as well as all City and offsite trees within 4 meters of the property line. The purpose of my consultation is to determine the viability of the trees and the potential impact in relation to the construction of a new triplex as well as upgrading of all services.

I conducted my assessment on August 5, 2022.



#### **METHODOLOGY**

- A level 2 Qualitative approach with a mallet and probe were used on accessible items without dissection, excavation, climbing or coring.
- All trees were inspected using a ground based visual examination.
- Photos have been included to help with tree identification.
- Drawings #1 and #2 show all trees, trees to be retained, and tree protection fencing.
- Trees were evaluated for their preservation potential based on health, structure, location, biotic, abiotic, pathogenic, decay and species factors. Topping cuts and codominant stems are considered structural defects and under most circumstances are considered structurally poor.
- Trees found to be unsafe, conflicting with the proposed building plans, of poor health or of little long term retentive value are recommended for removal in Table #1 and shown on drawing #1 with an X.
- The maximum amount of encroachment from excavation is generally around 30%. Further encroachment may de-stabilize the tree and is not recommended.
- A 1.5 meter excavation zone is calculated and used around the new house structure to show any potential conflicts with proposed construction.
- Driplines were used to establish Critical Root Zones (CRZ).

#### **OBSERVATIONS**

#### **Tree Resource**

The tree resource in this Report is made up of 23 trees in total.

Species totals are 12 Douglas fir, 7 Western red cedar, and one each of the following: Buckthorn, Cherry, Hemlock and Holly.

All onsite trees have been tagged. All trees have been located on the tree survey drawing.

#### Tree Inventory and Assessment - Table 1

The following Inventory Table provides individual tree data for all protected trees. Specific information includes:

- tree/tag number, offsite (OS), shared or City Tree (City, C), species
- diameter at breast height (DBH), approximate height, live crown ratio (LCR) %, deadwood %
- structural integrity a qualitative rating of a tree's shape and structure when compared to ideal trees of the same species and age class (good, fair, poor, dead)
- health the trees overall health and vigour (good, fair, poor, dead)
- · comments and recommendations
- Dripline radius, Critical Root Zones (CRZ)



Street view of property at time of assessment

**TABLE 1 - Tree Inventory and Assessment** 

LI	Report - 1590 Lancaster Street							
	бхрвн (т)	4.5	2.4	4.6	2.9	2.6	2.3	3.6
	Dripline radius CRZ	6.25	3.0	6.0	6.0	6.0	6.0	6.0
	Comments and Recommendations	Remove to allow for construction and services	Multi stemmed at base with .5 m included bark <b>Retain and Monitor</b>	Multi stemmed at base Hydro pruned Bark beetle entrance/exit holes <b>Retain and Monitor</b>	Hydro pruned Bark beetle entrance/exit holes <b>Retain and Monitor</b>	Hydro pruned Bark beetle entrance/exit holes <b>Retain and Monitor</b>	Hydro pruned Bark beetle entrance/exit holes <b>Retain and Monitor</b>	Multi stemmed at 1m with included bark Significant heartwood and sapwood decay on main stem Retain and Monitor
	Health	рооб	Fair	Fair	Fair	Fair	Fair	Poor
	Structural	дооб	Fair	Fair	Fair	Fair	Fair	Poor
٠	Dead wood (%)	10	25	25	25	25	25	70
	LCR (%)	85	50	75	75	75	75	30
	Height (m)	18	9	15	15	15	15	∞
	Ст)	75	21, 19	38, 38	48	42	38	59
	Common/Botanical name	Western red cedar Thuja plicata	Hemlock Tsuga heterophylla	Douglas fir Pseudotsuga menziesii	Douglas fir Pseudotsuga menziesii	Douglas fir Pseudotsuga menziesii	Douglas fir Pseudotsuga menziesii	Cascara buckthorn Rhamnus purshiana
	Tag #	C1	2	1801	1802	1803	1804	1805

**TABLE 1 - Tree Inventory and Assessment** 

Report - 1590 Lancaster Street							
6X DBH (m)	2.3	1.8	2.5	5.8	2.7	2.3	3.4
Dripline radius (m) CRZ	6.0	6.0	6.0	6.0	6.0	6.0	6.25
Comments and Recommendations	Hydro pruned Bark beetle entrance/exit holes Topped at 6m <b>Retain and Monitor</b>	Hydro pruned Bark beetle entrance/exit holes <b>Remove due to health</b>	Hydro pruned Bark beetle entrance/exit holes <b>Retain and Monitor</b>	Multi stemmed at base Hydro pruned <b>Retain and Monitor</b>	Topped at 8m Minor bark beetle entrance/exit holes Hydro pruned <b>Retain and Monitor</b>	Topped at 8m Minor bark beetle entrance/exit holes Hydro pruned <b>Retain and Monitor</b>	Multi stemmed at base and 8m Remove to allow for construction
Health	Poor	Dead	рооб	роод	Poor	Poor	poog
Structural	Poor	Dead	Good	Fair	Poor	Poor	Poor
Dead wood (%)	50	100	10	10	15	40	10
LCR (%)	35	0	15	80	65	40	80
Height (m)	∞	∞	18	15	17	∞	15
рвн (ст)	37	30	41	37, 25, 34	45	37	35, 21
Common/Botanical name	Douglas fir Pseudotsuga menziesii	Douglas fir Pseudotsuga menziesii	Douglas fir Pseudotsuga menziesii	Western red cedar Thuja plicata	Douglas fir Pseudotsuga menziesii	Douglas fir Pseudotsuga menziesii	Western red cedar Thuja plicata
Tag#	1806	1807	1808	1809	1810	1811	1812

**TABLE 1 - Tree Inventory and Assessment** 

6х DBH (m)	2.9	4.5	6.3	5.2	2.4	4.1	5.0
Dripline radius CRZ	6.25	6.25	6.25	6.25	3.75	6.5	9.25
Comments and Recommendations	Multi stemmed at 14m Remove to allow for construction	Bark beetle entrance/exit holes Remove to allow for construction	Multi stemmed at base  Remove to allow for construction	Multi stemmed at base with included bark  Remove to allow for construction	Remove to allow for construction	Remove to allow for construction	Multi stemmed at 15m Remove to allow for construction
Health	рооб	рооб	рооб	рооб	рооб	poog	poog
Structural	Fair	poog	Fair	Fair	poog	рооб	Fair
Dead wood (%)	10	5	10	10	< <u>\$</u>	S	5
LCR (%)	85	75	70	70	80	65	65
Height (m)	15	24	17	17	∞	23	24
cm)	47	74	56, 49	98	40	89	83
Common/Botanical name	Western red cedar Thuja plicata	Douglas fir Pseudotsuga menziesii	Western red cedar Thuja plicata	Western red cedar Thuja plicata	Holly Ilex aquifollium	Western red cedar Thuja plicata	Douglas fir Pseudotsuga menziesii
Tag #	1813	1814	1815	1816	051	1817	1818

# **TABLE 1 - Tree Inventory and Assessment**

CRZ 6X DBH (m)	1.8	5.6
Dripline radius	3.25	7.0
Comments and Recommendations	Multi stemmed at 2m <b>Retain and Monitor</b>	Needs wire clearance pruning if retained Hydro pruned Bark beetle entrance/exit holes Dark spots present at base, on main trunk Remove to allow for construction and services
Health	poog	роод
Structural Integrity	рооб	рооо
Dead wood Structural (%) Integrity	ß	\$
LCR (%)	09	70
Height (m)	4.5	21
ОВН (сш)	30	£ 6
Common/Botanical name	Cherry Prunus avium	Douglas fir Pseudotsuga menziesii
Tag #	082	1819

#### **SUMMARY AND RECOMMENDATIONS**

#### Viability of trees

Tree #1807 is dead/dying or in a state of decline beyond repair and is recommended for removal. All other trees are viable for long term retention.

#### **Development impact on trees**

Trees #1801, 1802, 1803 and 1804 will have encroachment into their critical root zones from a parking pad. Arborist supervision and an above grade design using paving stones is recommended.

Tree #1809 and OS1 will have 45% and 40% encroachment into their critical root zones from the new house excavation zone. Tree #OS1 is recommended for removal due to conflicts with construction. Tree #1809 is recommended for retention with Arborist supervision and supplemental watering during excavation. Tree #1809 is an anchor to the surrounding grove therefore extra measures should be taken to retain it.

Trees #1805, 1813, 1814, 1815, and 1816 will have 100% encroachment into their critical root zones and are therefore recommended for removal due to conflicts with construction.

Trees #1817 and 1818 will have 89% and 39% encroachment from the new house excavation zone into their critical root zones and are therefore recommended for removal due to conflicts with construction.

#### Potential conflicts with services

All services come from Lancaster Street into the critical root zones of trees #1819 and #C1 and are therefore recommended for removal due to conflicts with services.

#### **GENERAL NOTES**

- 1. Replacement trees must meet the plant condition and structure requirements set out in the latest edition of the BCSLA/BCLNA "B.C. Landscape Standard" and the CNTA "Canadian Standards for nursery stock".
- 2. Replacement trees must be located, planted and maintained in accordance with the BCSLA/ BCLNA and "White Rock Tree Management Bylaw NO. 2407".
- 3. Replacement trees must be a minimum size of 3.0m ht. coniferous / 6 cm cal. deciduous
- 4. Trees must be located a minimum distance of 1m from any property lines and 3m from any other tree or buildings/services.

**TABLE 2 - Tree Protection Summary** 

	Onsite	Offsite	City	Total
Number of protected trees identified	19	2	2	23
Number of protected trees to be Removed	9	1	1	11
Number of protected trees to be retained	10	1	1	12
Number of replacement Trees required at 2:1	2	2	0	4
Number of replacement Trees required at 3:1	6	0	0	6
Number of replacement Trees required at 4:1	8	0	4	12
Number of replacement Trees required at 5:1	5	0	0	5
Number of replacement Trees required at 6:1	18	0	0	18
Number of replacement trees required	39	2	4	45
Number of replacement trees proposed	TBD	TBD	TBD	TBD
Number of replacement trees in deficit	TBD	TBD	TBD	TBD
Total number of retained trees & replacement trees		TBD		

#### TREE PROTECTION PLAN

Tree protection shall be done in accordance with White Rock Tree Management Bylaw No. 2407. Tree protection fencing is not required if all protected trees are removed prior to construction. If trees are to be retained, then tree protection fencing is to be installed prior to construction with no excavation, grade alterations or materials storage within the Tree Protection Zones (TPZ) unless preapproved by the project Arborist. TPZs are listed on the Tree Retention Plan. The project Arborist must be contacted prior to and be on site for any construction within the recommended TPZ inside the Tree Protection Barriers. All parties must be aware that long-term success in tree preservation efforts depends greatly on minimizing the impact caused during and post construction. Mechanical injuries caused to trees above or below ground are difficult to repair and can cause long term damage or death. Best efforts must be made to ensure that soils remain undisturbed within the tree protection zones.



Photo 1
View of property from North Bluff Road.



Photo 2
Trees along North Bluff Road are Hydro-pruned.



Photo 3
Trees #1807, 1808 and 1809 from left to right.



Photo 4 Tree #OS1.

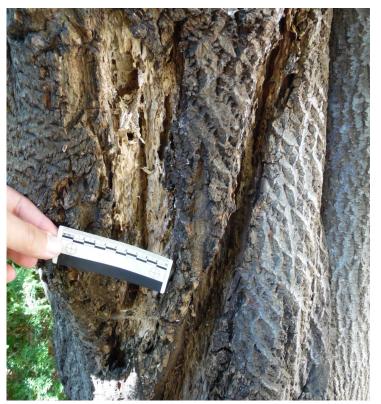



Photo 5
Tree #1805 has extensive decay found in the main trunk.




Photo 6
Tree #OS2 behind trailer.



Photo 7 Tree #1819.

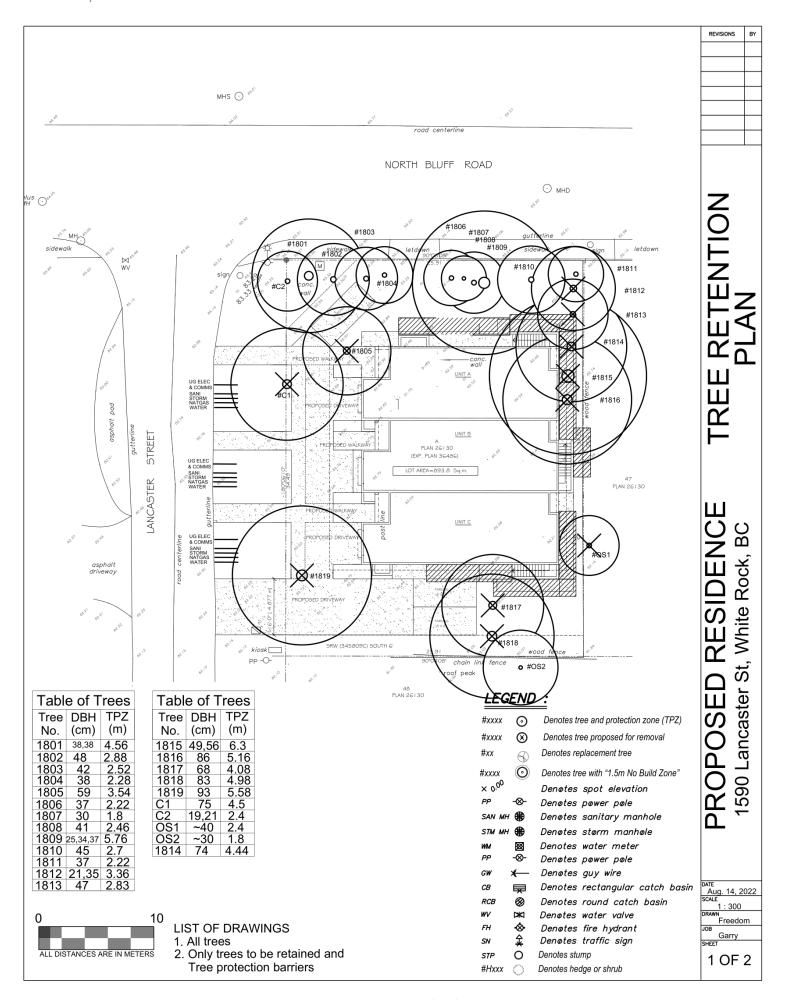

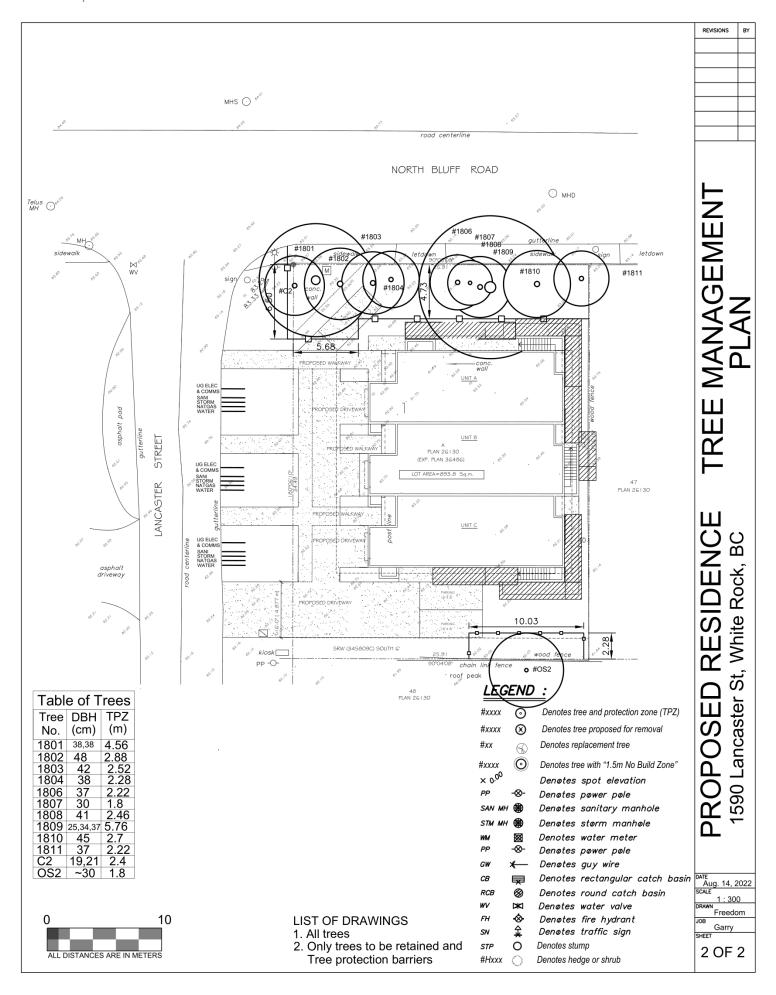

#### **ASSUMPTIONS AND LIMITING CONDITIONS**

- Information contained in this report covers only those items that were examined and reflects conditions of those items at the time of assessment. The assessment is limited to visual examination of accessible items without dissection, excavation, climbing or coring.
- Care has been taken to obtain all information from reliable sources. All data has been verified insofar as possible, however, Freedom Tree Care Ltd can neither guarantee nor be responsible for the accuracy of information.
- Any legal description provided to the consultant is assumed to be correct. Any titles and ownerships
  to any property are assumed to be good and marketable. No responsibility is assumed for matters
  legal in character. Freedom Tree Care Ltd shall not be required to give testimony or to attend court
  by reason of this report unless subsequent contractual arrangements are made.
- Loss or altercation of any part of this report invalidates the entire report.
- This report shall be used for its intended purpose only and by the parties to whom it is addressed.
   Neither all or any part of the contents of this report, nor copy thereof, shall be conveyed by anyone, including the client, to the public through advertising, public relations, news, sales, or other media, without the prior expressed written and verbal consent of Freedom Tree Care Ltd.
- Sketches, diagrams, graphs and photographs in this report, being intended as visual aids, are not necessarily to scale and should not be constructed as engineering or architectural reports or surveys.
- There is no warranty or guarantee expressed or implied, that problems or deficiencies of the tree or other plant or property in question may not arise in the future.

I certify that this report has been prepared in accordance with accepted Arboricultural standards from the information made available to me at the time, and that the facts and opinions expressed within it are true and accurate to the best of my knowledge and belief.

If there are any questions regarding the contents of this report, please contact Freedom Tree Care Ltd.

Freedom Sukenick

ISA Certified Arborist #PN-7712A

Certified Tree Risk Assessor (TRAQ)

Arradon Suberich

Freedom Tree Care Ltd.